
#### SHEET LIST

**COVER SHEET** LOCALITY PLAN SITE ANALYSIS **EXISTING CONDITIONS DEMO PLAN** DA05 SITE PLAN PROPOSED FLOOR PLAN - WAREHOUSE 1 PROPOSED FLOOR PLAN - WAREHOUSE 2 DA08 **ROOF PLAN ELEVATIONS & SECTIONS - OVERALL ELEVATIONS & SECTIONS - WAREHOUSE 1** ELEVATIONS & SECTIONS - WAREHOUSE 2 PROPOSED OFFICE PLAN TYPICAL - WAREHOUSE 1 PROPOSED OFFICE PLAN TYPICAL - WAREHOUSE 2 DA13 TYPICAL PYLON SIGNAGE DETAILS





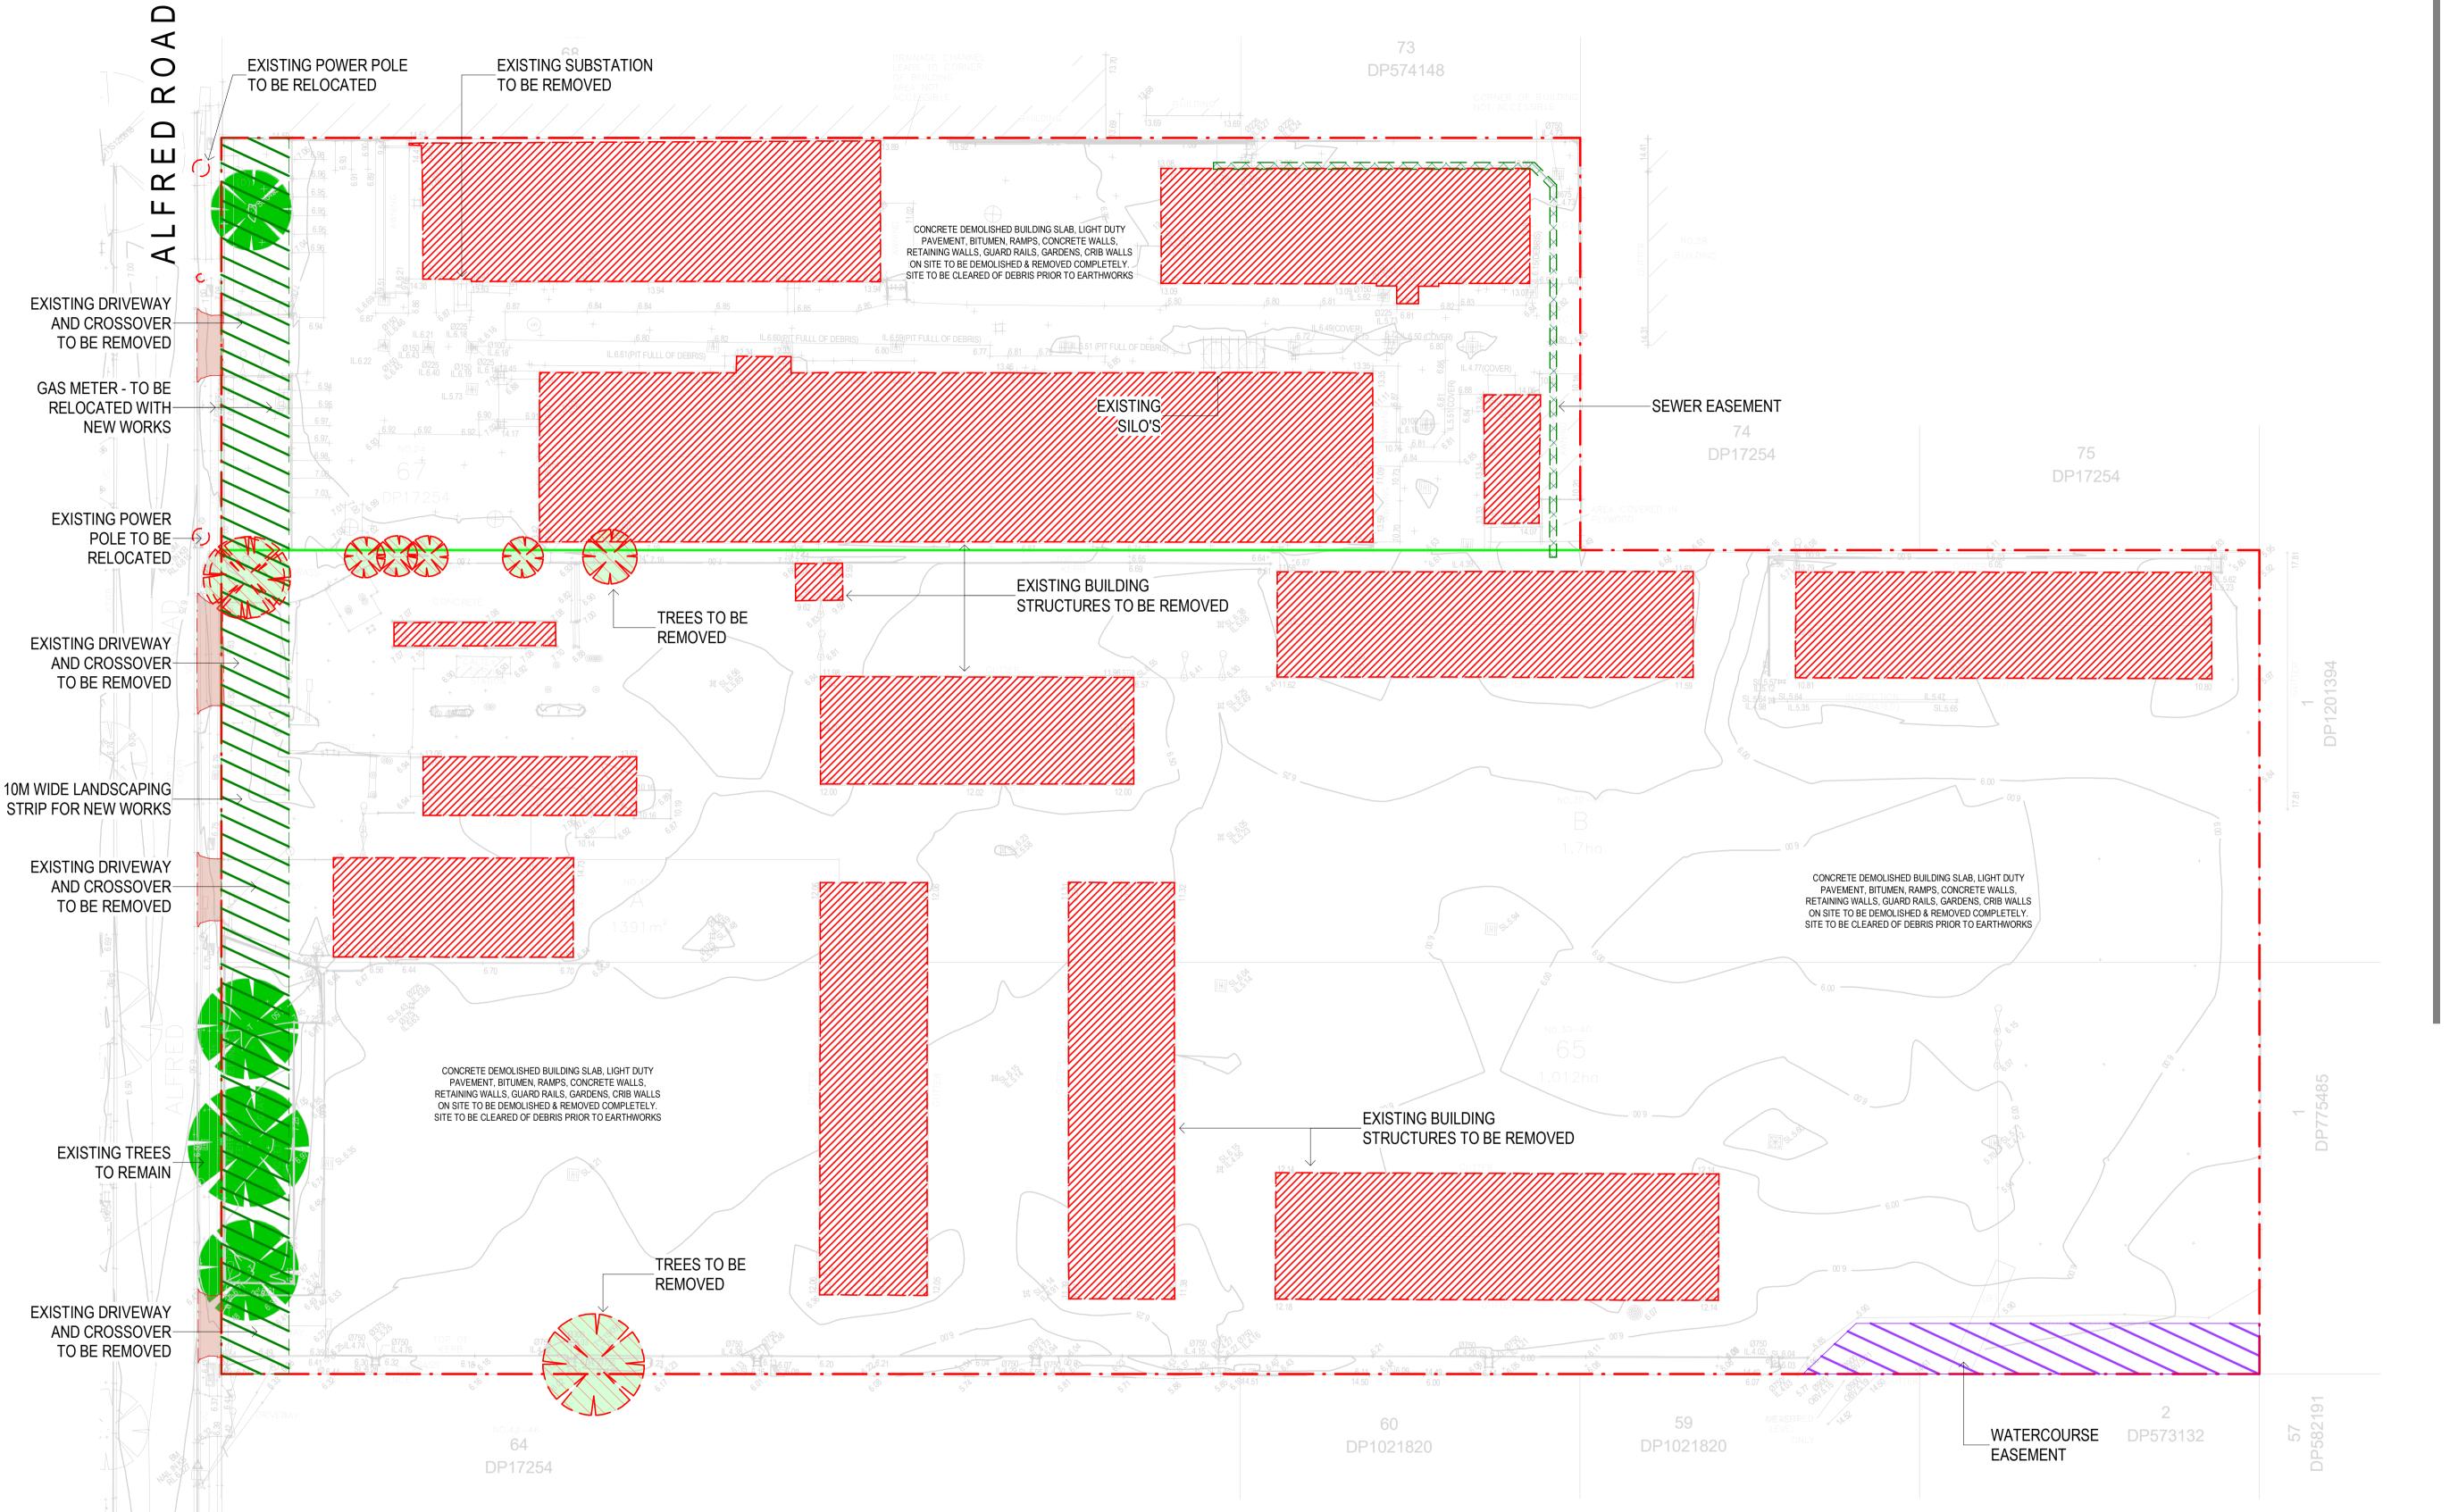

30.05.2022 ISSUED FOR APPROVAL 18.04.2023 26.04.2023 ISSUED FOR APPROVAL 25.05.2023 ISSUED FOR APPROVAL ISSUED FOR LODGEMENT 15.06.2023

**NOTES - DEMOLITION** 

CONTRACTOR IS TO ALLOW TO DEMOLISH ALL STRUCTURES AND TERMINATE ALL SERVICES ABOVE GROUND. ALL FOOTINGS, FOUNDATIONS AND IN GROUND SERVICES ETC., WILL BE THE RESPONSIBILITY OF BUILDING WORKS HEAD CONTRACTOR. CONTRACTOR IS TO CONFIRM LOCATION OF ALL EXISTING IN

GROUND SERVICES PRIOR TO COMMENCEMENT OF WORKS.

ALL DEMOLITION WORKS ARE TO BE IN ACCORDANCE WITH APPLICABLE PORTIONS OF THE LATEST FOLLOWING CURRENT

AND ALSO MUST COMPLY WITH THE REQUIREMENTS OF:

MAKE GOOD TO ORIGINAL CONDITION, DAMAGE TO STRUCTURES TO

BE RETAINED AND TO ADJACENT PROPERTY WITH RESULTS FROM DEMOLITION OPERATIONS. ALL RESTORATION WORK IS TO BE PERFORMED WITH OUT EXPENSES TO THE PROPRIETOR.

ANY DAMAGE TO PATHS, NATURE STRIPS, GARDEN BEDS ETC. TO

ADJOINING STREETS, ARE TO BE MADE GOOD AT THE

DEMOLISHED MATERIALS BECOME PROPERTY OF THE

DEMOLITION WORKS WILL BE DEEMED COMPLETE WHEN

REMOVAL OF TREES IS TO INCLUDE GRUBBING OF ROOTS.

WHETHER ANY ASBESTOS IS PRESENT ON SITE AND MAKE PROVISION FOR ITS REMOVAL IN STRICT ACCORDANCE WITH

LEGEND - DEMOLITION

EXTENT OF SITE TO BE DEMOLISHED &

WATER EASEMENT

REMOVED COMPLETELY.

PARTS OF STRUCTURE LISTED &/OR DRAWN

FOR DEMOLITION AS INDICATED.

EXISTING BUILDING AND ANCILLARY STRUCTURES TO BE REMOVED

INDICATES EXTENT OF CONCRETE DEMOLISHED BUILDING SLAB, LIGHT DUTY PAVEMENT, BITUMEN,

RAMPS, CONCRETE WALLS, RETAINING WALLS, GUARD RAILS, GARDENS, CRIB WALLS ON SITE TO

TREES TO BE REMOVED FOR CONSTRUCTION AND SITE WORKS, IN ACCORDANCE WITH ARBORIST REPORT

BE DEMOLISHED & REMOVED COMPLETELY

CONTRACTOR LEAVES SITE IN CLEAN AND LEVELED STATE.

CONTRACTOR IS TO PROVIDE SOLID HOARDING TO ENTIRE SITE

CONTRACTOR IS TO ALLOW FOR AN INSPECTION TO ASCERTAIN

CONTRACTOR AND ARE TO BE REMOVED FROM SITE.

BOUNDARY DURING ALL DEMOLITION WORKS.

PROVIDE BEFORE AND AFTER PHOTOGRAPHIC RECORD OF PROGRESS OF WORKS INCLUDING DILAPIDATION REPORT ON

MISUNDERSTANDING OF SCOPE OF WORKS.

AUSTRALIAN STANDARDS:

- BASE BUILDING GUIDELINES

CONTRACTORS EXPENSE.

ADJOINING PROPERTIES.

- AS-2436 - AS-2601

- LOCAL COUNCIL

CONTRACTOR IS TO VISIT THE SITE AND ASCERTAIN ALL ON SITE CONDITIONS. NO VARIATION WILL BE APPROVED CAUSED BY A


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SITE PLAN



DATE: APRIL, 2023 SCALE: 1:500@A1 1:1000@A3 SCALE:



(INCLUDING (EXCLUDING

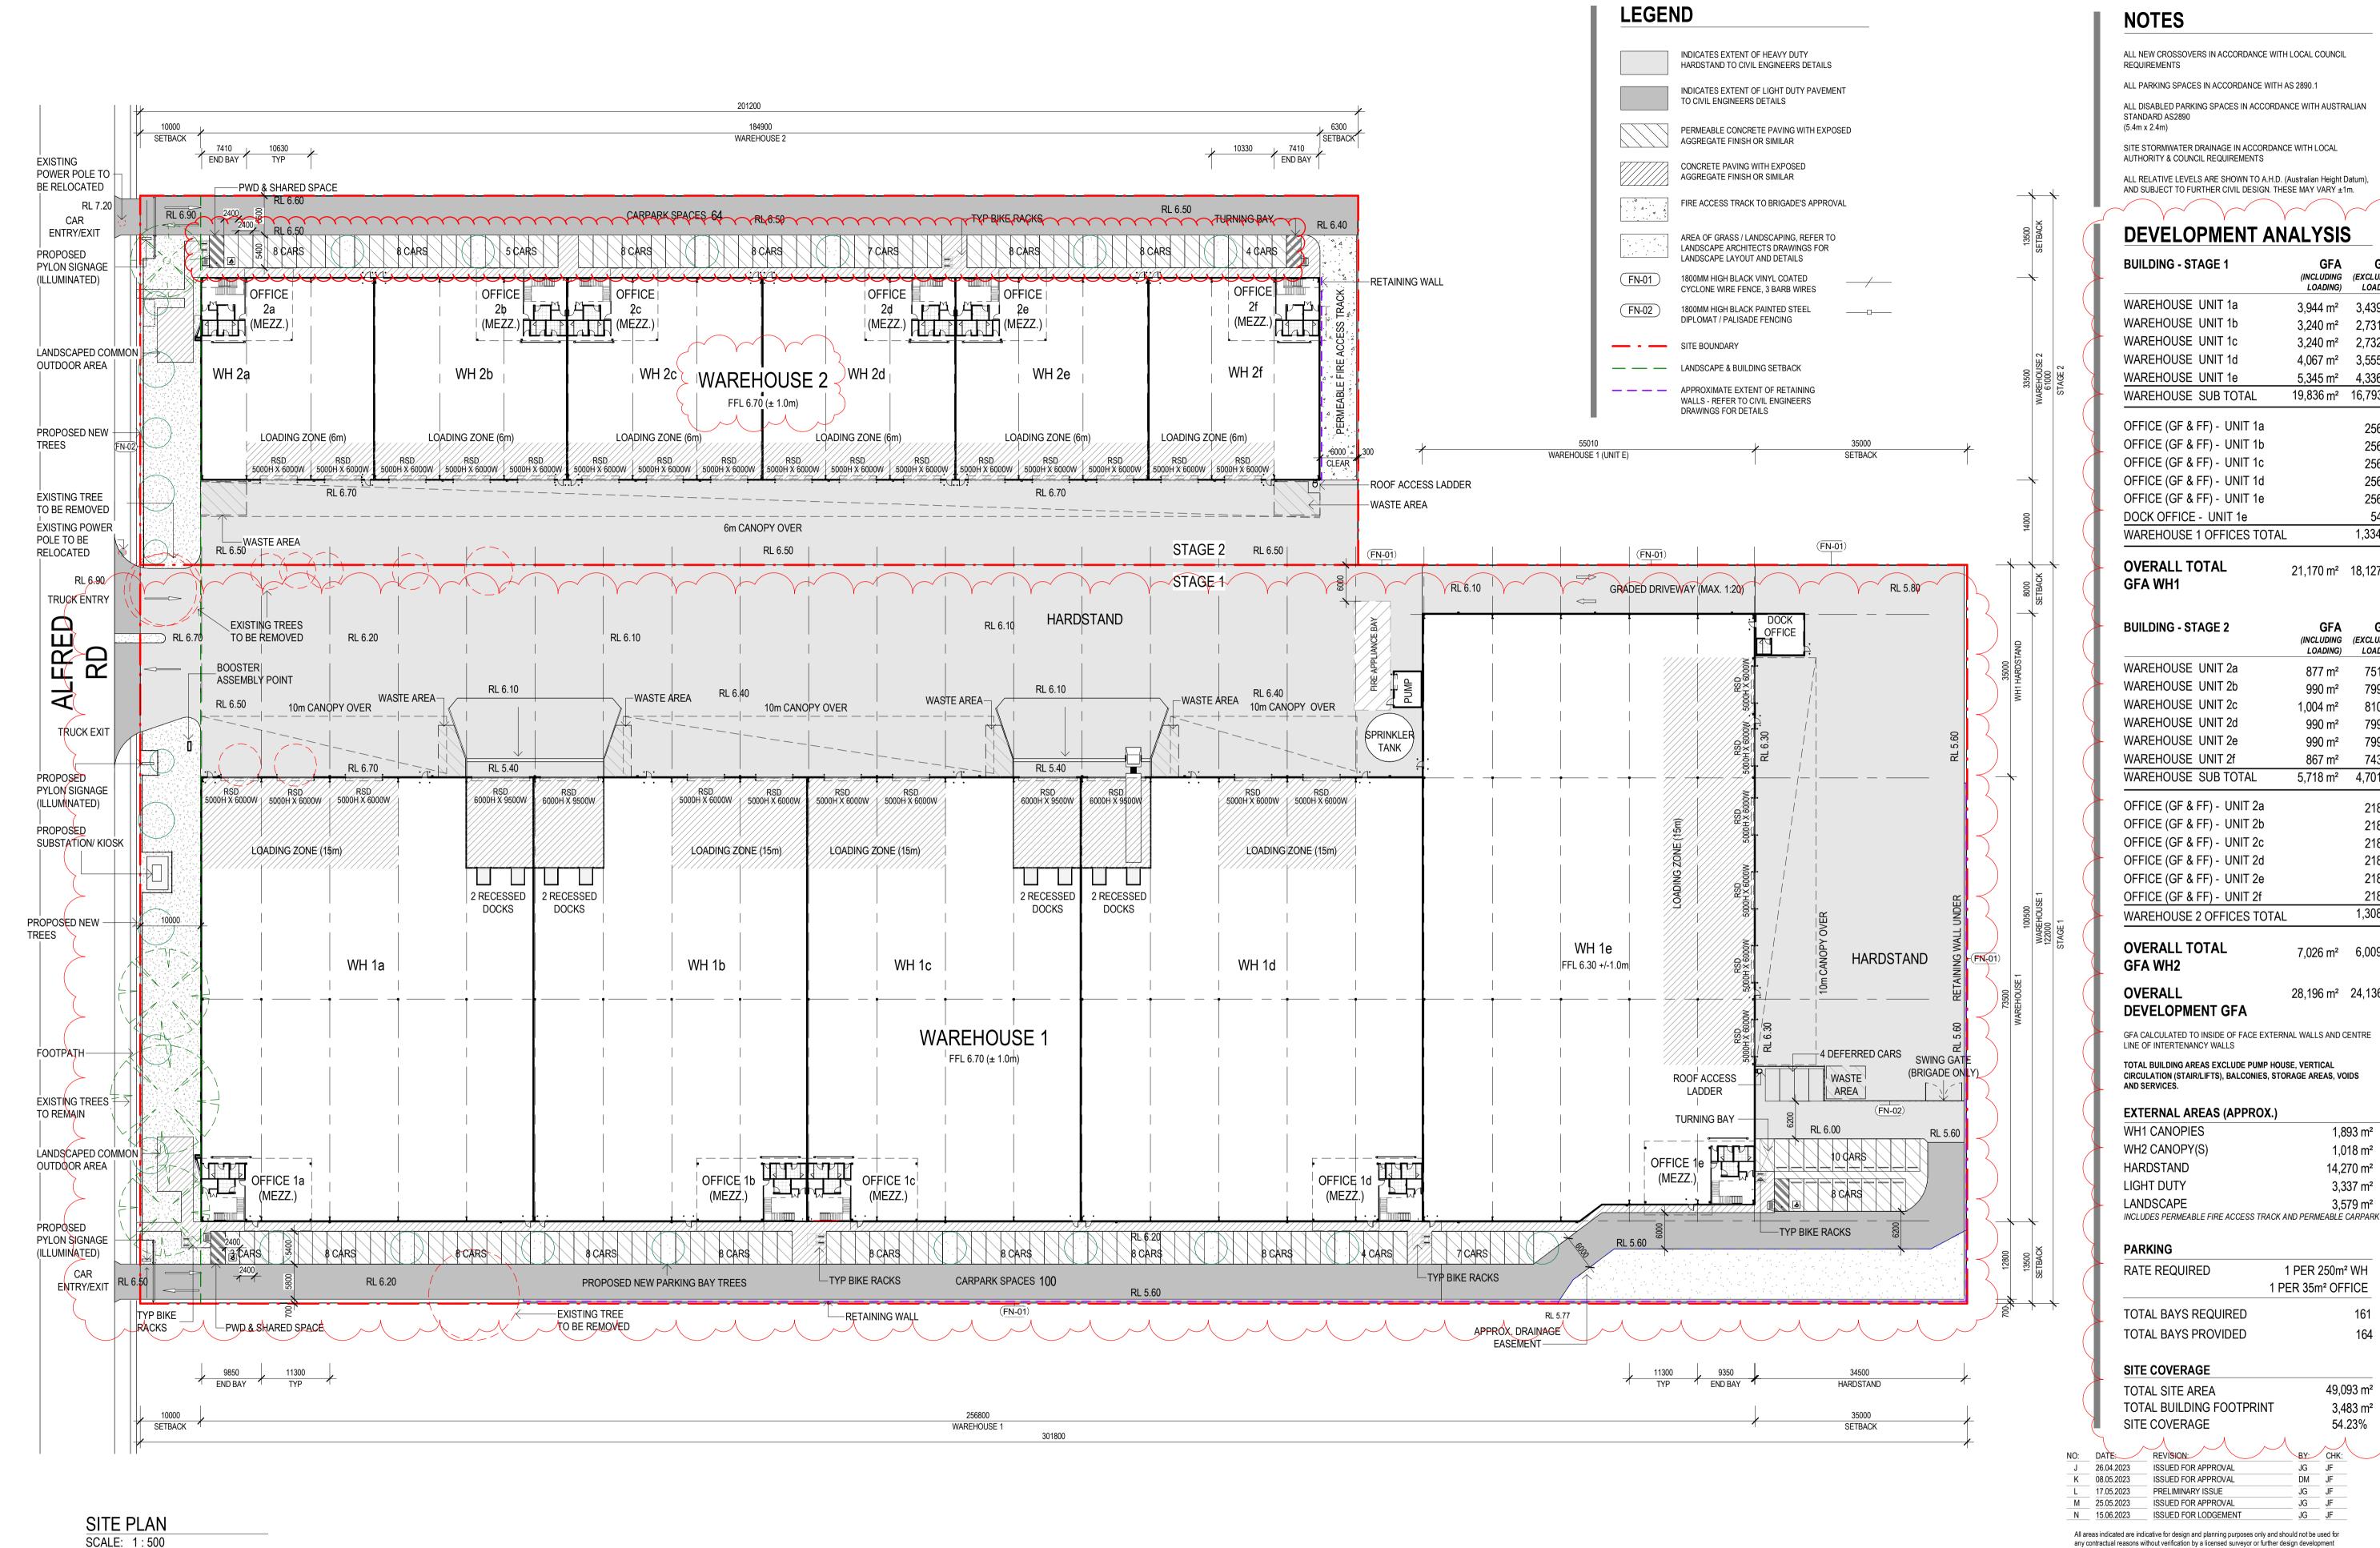3,944 m<sup>2</sup> 3,439 m<sup>2</sup>

3,240 m<sup>2</sup> 2,732 m<sup>2</sup>

4,067 m<sup>2</sup> 3,555 m<sup>2</sup>

5,345 m<sup>2</sup> 4,336 m<sup>2</sup>

19,836 m<sup>2</sup> 16,793 m<sup>2</sup>

21,170 m<sup>2</sup> 18,127 m<sup>2</sup>

(INCLUDING (EXCLUDING

LOADING)

867 m<sup>2</sup>

5,718 m<sup>2</sup> 4,701 m<sup>2</sup>

7,026 m<sup>2</sup> 6,009 m<sup>2</sup>

28,196 m<sup>2</sup> 24,136 m<sup>2</sup>

1,893 m<sup>2</sup>

1,018 m<sup>2</sup>

14,270 m<sup>2</sup>

3,337 m<sup>2</sup>

3,579 m<sup>2</sup>

49,093 m<sup>2</sup>

3,483 m<sup>2</sup>

54.23%

256 m²

256 m<sup>2</sup>

256 m<sup>2</sup>

256 m<sup>2</sup>

256 m<sup>2</sup>

54 m<sup>2</sup>

1,334 m<sup>2</sup>

LOADING)

799 m<sup>2</sup>

799 m<sup>2</sup>

799 m<sup>2</sup>

743 m<sup>2</sup>

218 m<sup>2</sup>

218 m<sup>2</sup>

218 m<sup>2</sup>

218 m<sup>2</sup>

218 m<sup>2</sup>

218 m<sup>2</sup>


1,308 m<sup>2</sup>

LOADING)

3,240 m<sup>2</sup>

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PROPOSED DEVELOPMENT 24-40 ALFRED RD, CHIPPING NORTON NSW 2170

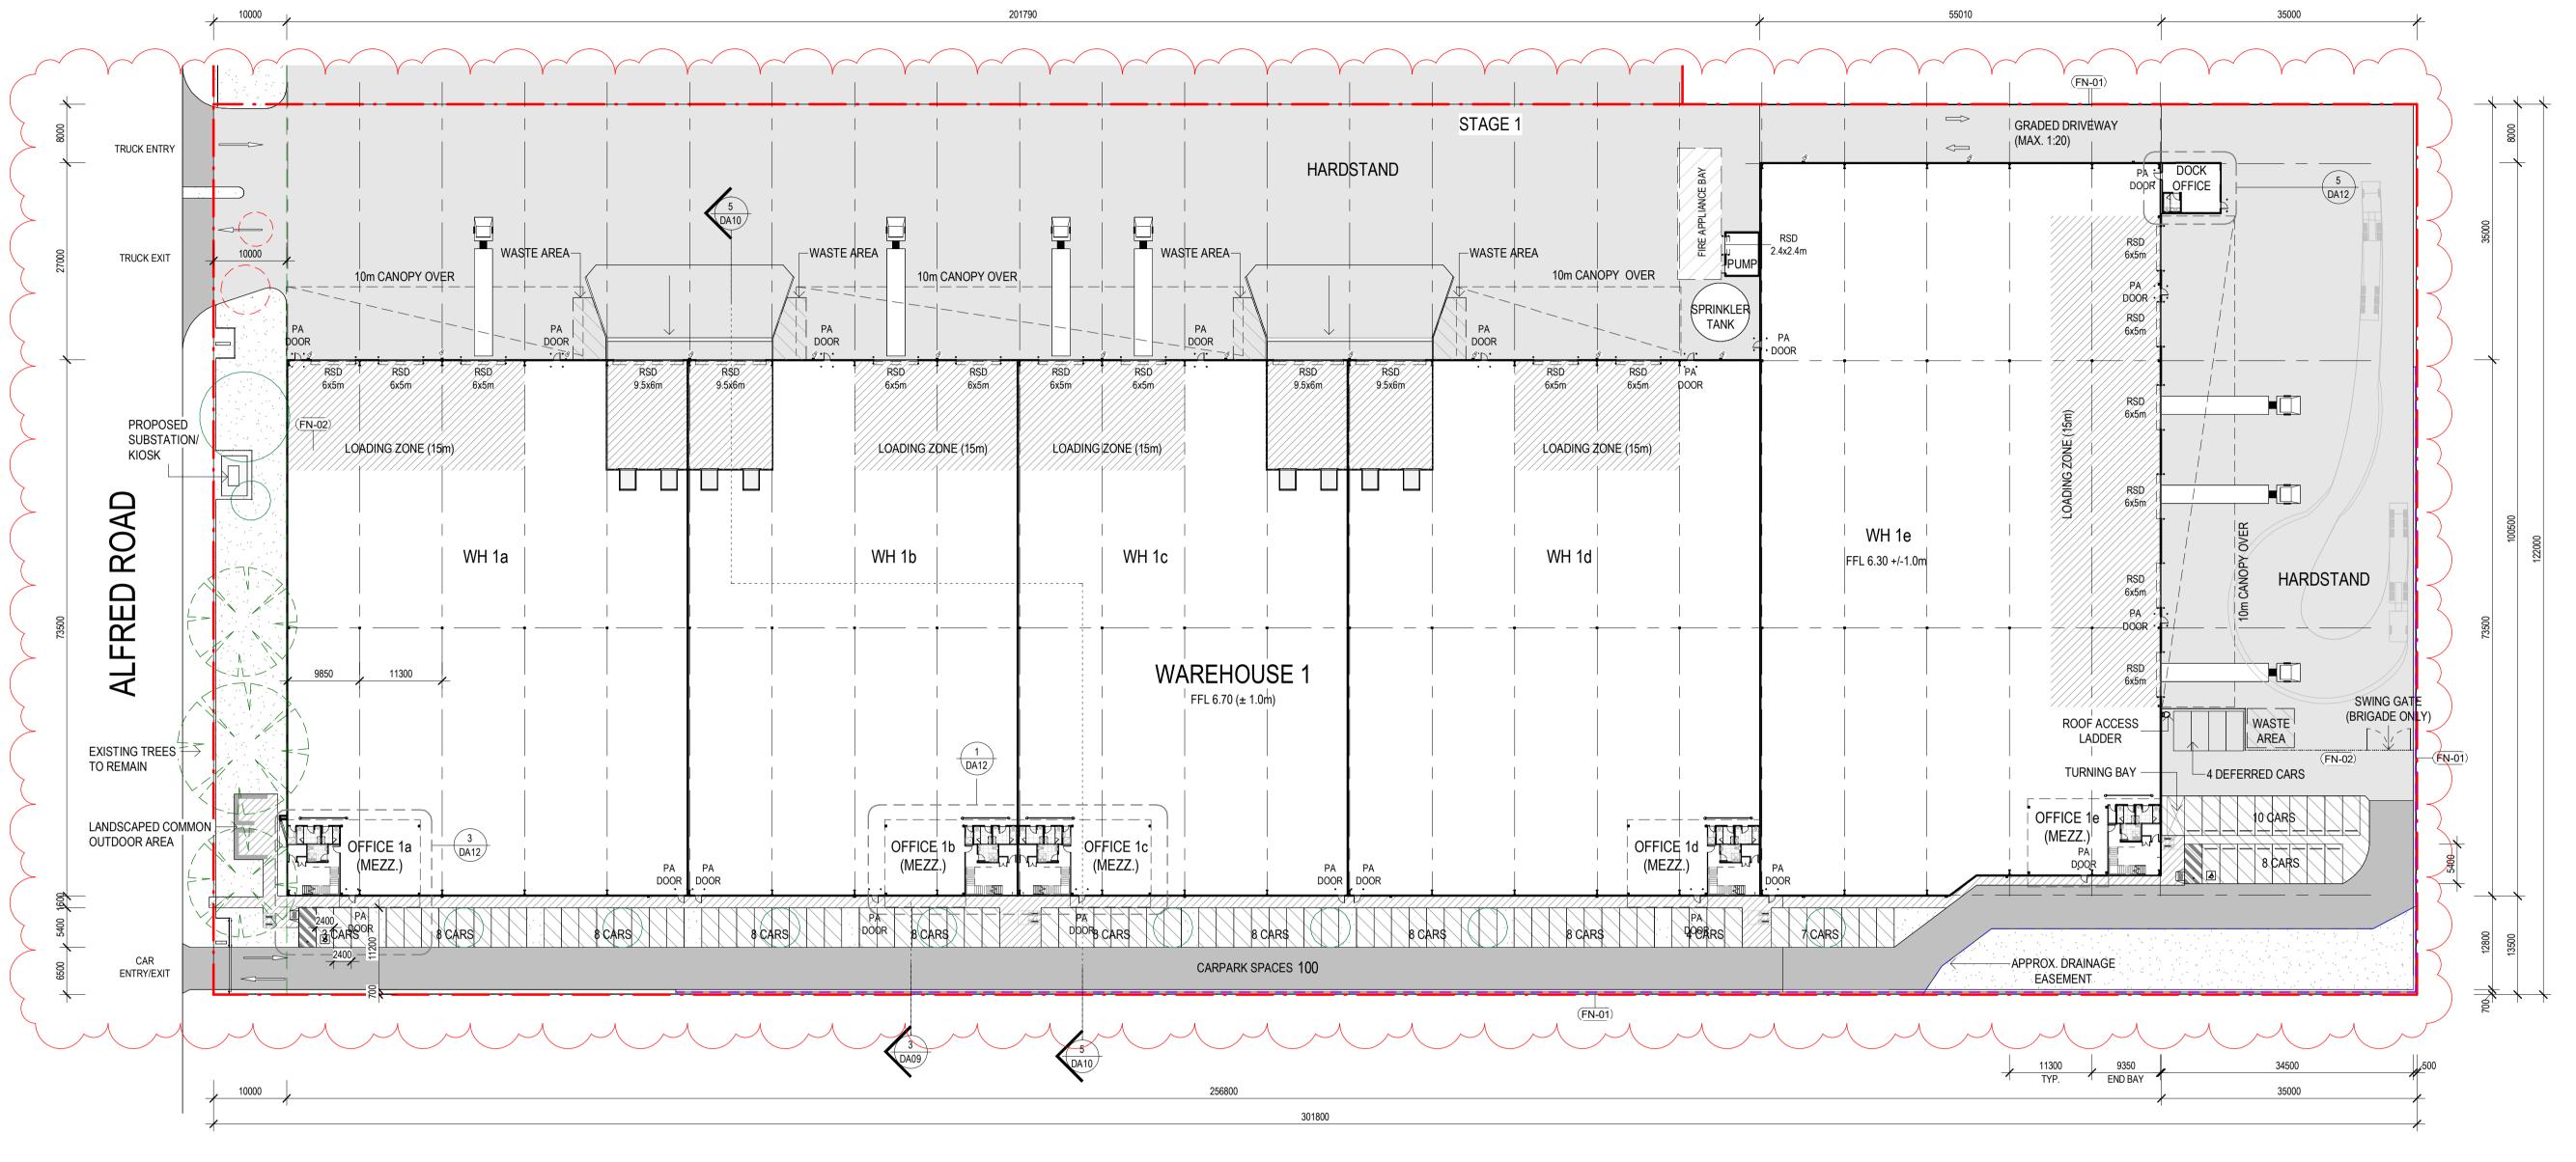

FLOOR PLAN - WAREHOUSE 1 SCALE: 1:500

> 26.04.2023 ISSUED FOR APPROVAL 08.05.2023 17.05.2023 PRELIMINARY ISSUE ISSUED FOR APPROVAL 25.05.2023 15.06.2023 ISSUED FOR LODGEMENT

**NOTES** 

STANDARD AS2890 (5.4m x 2.4m)

**LEGEND** 

ALL NEW CROSSOVERS IN ACCORDANCE WITH LOCAL COUNCIL

ALL DISABLED PARKING SPACES IN ACCORDANCE WITH AUSTRALIAN

ALL RELATIVE LEVELS ARE SHOWN TO A.H.D. (Australian Height Datum), AND SUBJECT TO FURTHER CIVIL DESIGN. THÈSE MAY VARY ±1m.

> INDICATES EXTENT OF HEAVY DUTY HARDSTAND TO CIVIL ENGINEERS DETAILS

TO CIVIL ENGINEERS DETAILS

AGGREGATE FINISH OR SIMILAR

CONCRETE PAVING WITH EXPOSED

AGGREGATE FINISH OR SIMILAR

INDICATES EXTENT OF LIGHT DUTY PAVEMENT

PERMEABLE CONCRETE PAVING WITH EXPOSED

FIRE ACCESS TRACK TO BRIGADE'S APPROVAL

AREA OF GRASS / LANDSCAPING, REFER TO LANDSCAPE ARCHITECTS DRAWINGS FOR LANDSCAPE LAYOUT AND DETAILS

1800MM HIGH BLACK VINYL COATED

DIPLOMAT / PALISADE FENCING

APPROXIMATE EXTENT OF RETAINING WALLS - REFER TO CIVIL ENGINEERS

DRAWINGS FOR DETAILS

- SITE BOUNDARY

— — LANDSCAPE & BUILDING SETBACK

CYCLONE WIRE FENCE, 3 BARB WIRES 1800MM HIGH BLACK PAINTED STEEL

SITE STORMWATER DRAINAGE IN ACCORDANCE WITH LOCAL

ALL PARKING SPACES IN ACCORDANCE WITH AS 2890.1


AUTHORITY & COUNCIL REQUIREMENTS

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PROPOSED DEVELOPMENT 24-40 ALFRED RD, CHIPPING NORTON NSW 2170

PROPOSED FLOOR PLAN -WAREHOUSE 2



APRIL, 2023 1:500@A1 1:1000@A3

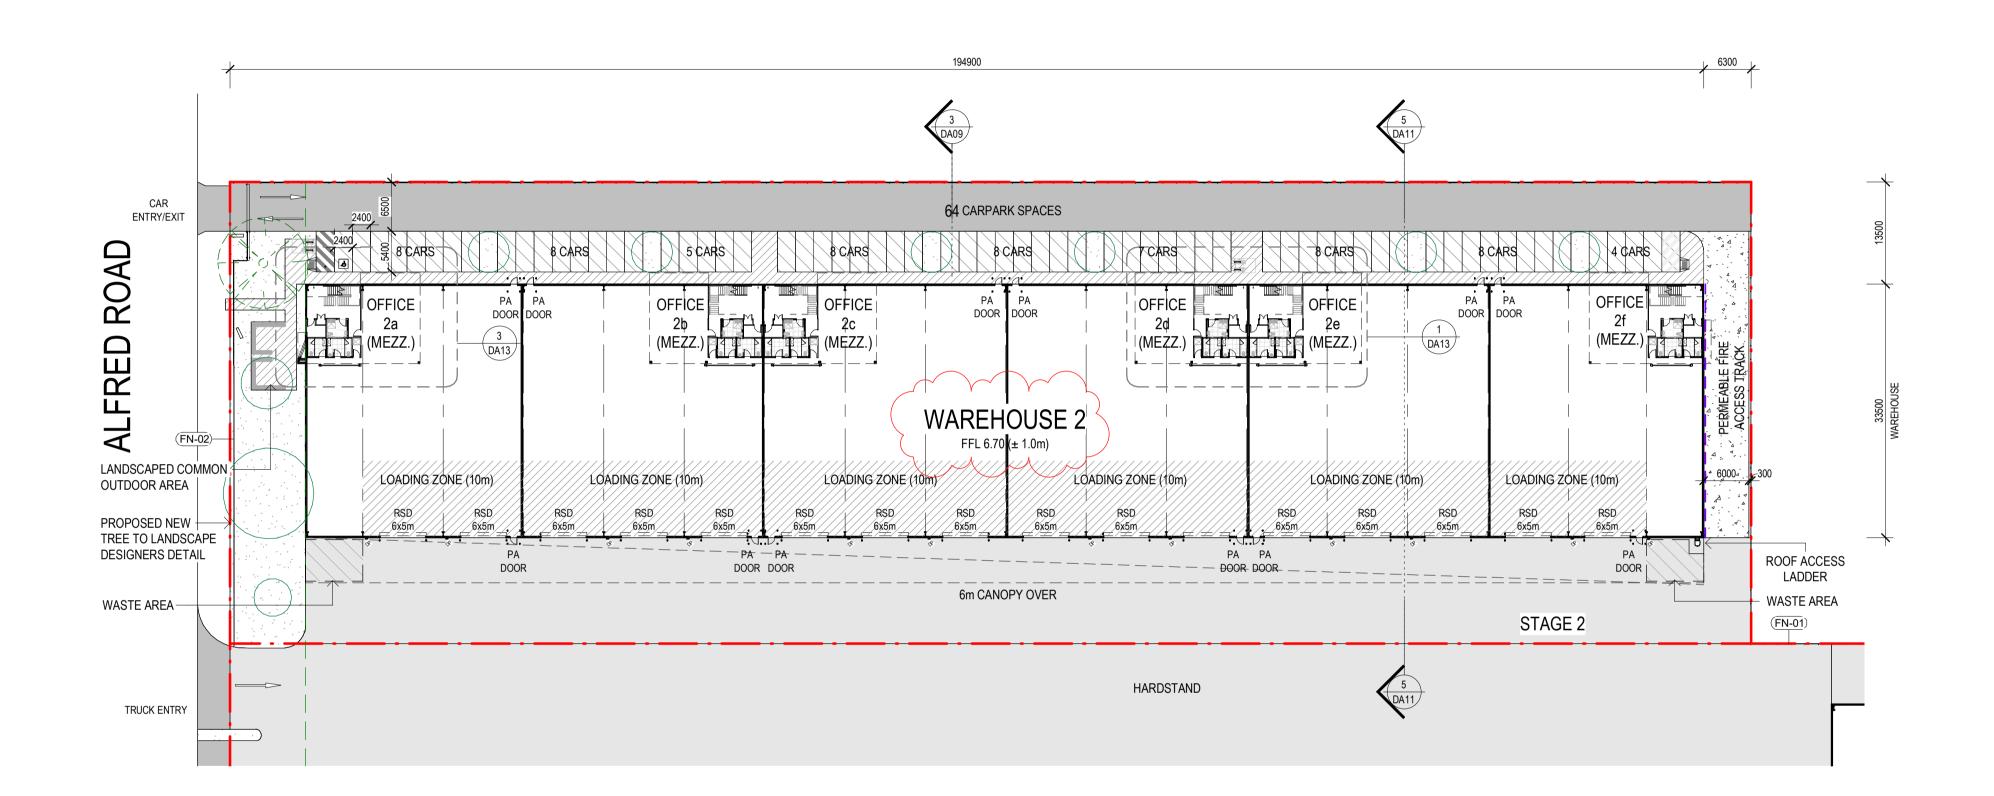21420 DA07



NO:	DATE:	REVISION:	BY:	CHK:
С	09.02.2023	ISSUED FOR APPROVAL	AS	JF
D	18.04.2023	ISSUED FOR APPROVAL	DM	JF
Е	26.04.2023	ISSUED FOR APPROVAL	JG	JF

**NOTES** 

REQUIREMENTS

STANDARD AS2890 (5.4m x 2.4m)

**LEGEND** 

ALL NEW CROSSOVERS IN ACCORDANCE WITH LOCAL COUNCIL

SITE STORMWATER DRAINAGE IN ACCORDANCE WITH LOCAL

AUTHORITY & COUNCIL REQUIREMENTS

ALL DISABLED PARKING SPACES IN ACCORDANCE WITH AUSTRALIAN

ALL RELATIVE LEVELS ARE SHOWN TO A.H.D. (Australian Height Datum), AND SUBJECT TO FURTHER CIVIL DESIGN. THESE MAY VARY ±1m.

> INDICATES EXTENT OF HEAVY DUTY HARDSTAND TO CIVIL ENGINEERS DETAILS

TO CIVIL ENGINEERS DETAILS

AGGREGATE FINISH OR SIMILAR

CONCRETE PAVING WITH EXPOSED AGGREGATE FINISH OR SIMILAR

FN-01 1800MM HIGH BLACK VINYL COATED

— — LANDSCAPE & BUILDING SETBACK

— — — APPROXIMATE EXTENT OF RETAINING

DRAWINGS FOR DETAILS

- SITE BOUNDARY

INDICATES EXTENT OF LIGHT DUTY PAVEMENT

PERMEABLE CONCRETE PAVING WITH EXPOSED

FIRE ACCESS TRACK TO BRIGADE'S APPROVAL

AREA OF GRASS / LANDSCAPING, REFER TO LANDSCAPE ARCHITECTS DRAWINGS FOR LANDSCAPE LAYOUT AND DETAILS

CYCLONE WIRE FENCE, 3 BARB WIRES

1800MM HIGH BLACK PAINTED STEEL DIPLOMAT / PALISADE FENCING

WALLS - REFER TO CIVIL ENGINEERS

ALL PARKING SPACES IN ACCORDANCE WITH AS 2890.1

All areas indicated are indicative for design and planning purposes only and should not be used for any contractual reasons without verification by a licensed surveyor or further design development


ISSUED FOR APPROVAL


ISSUED FOR LODGEMENT

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F 25.05.2023

G 15.06.2023



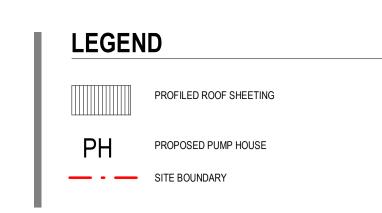

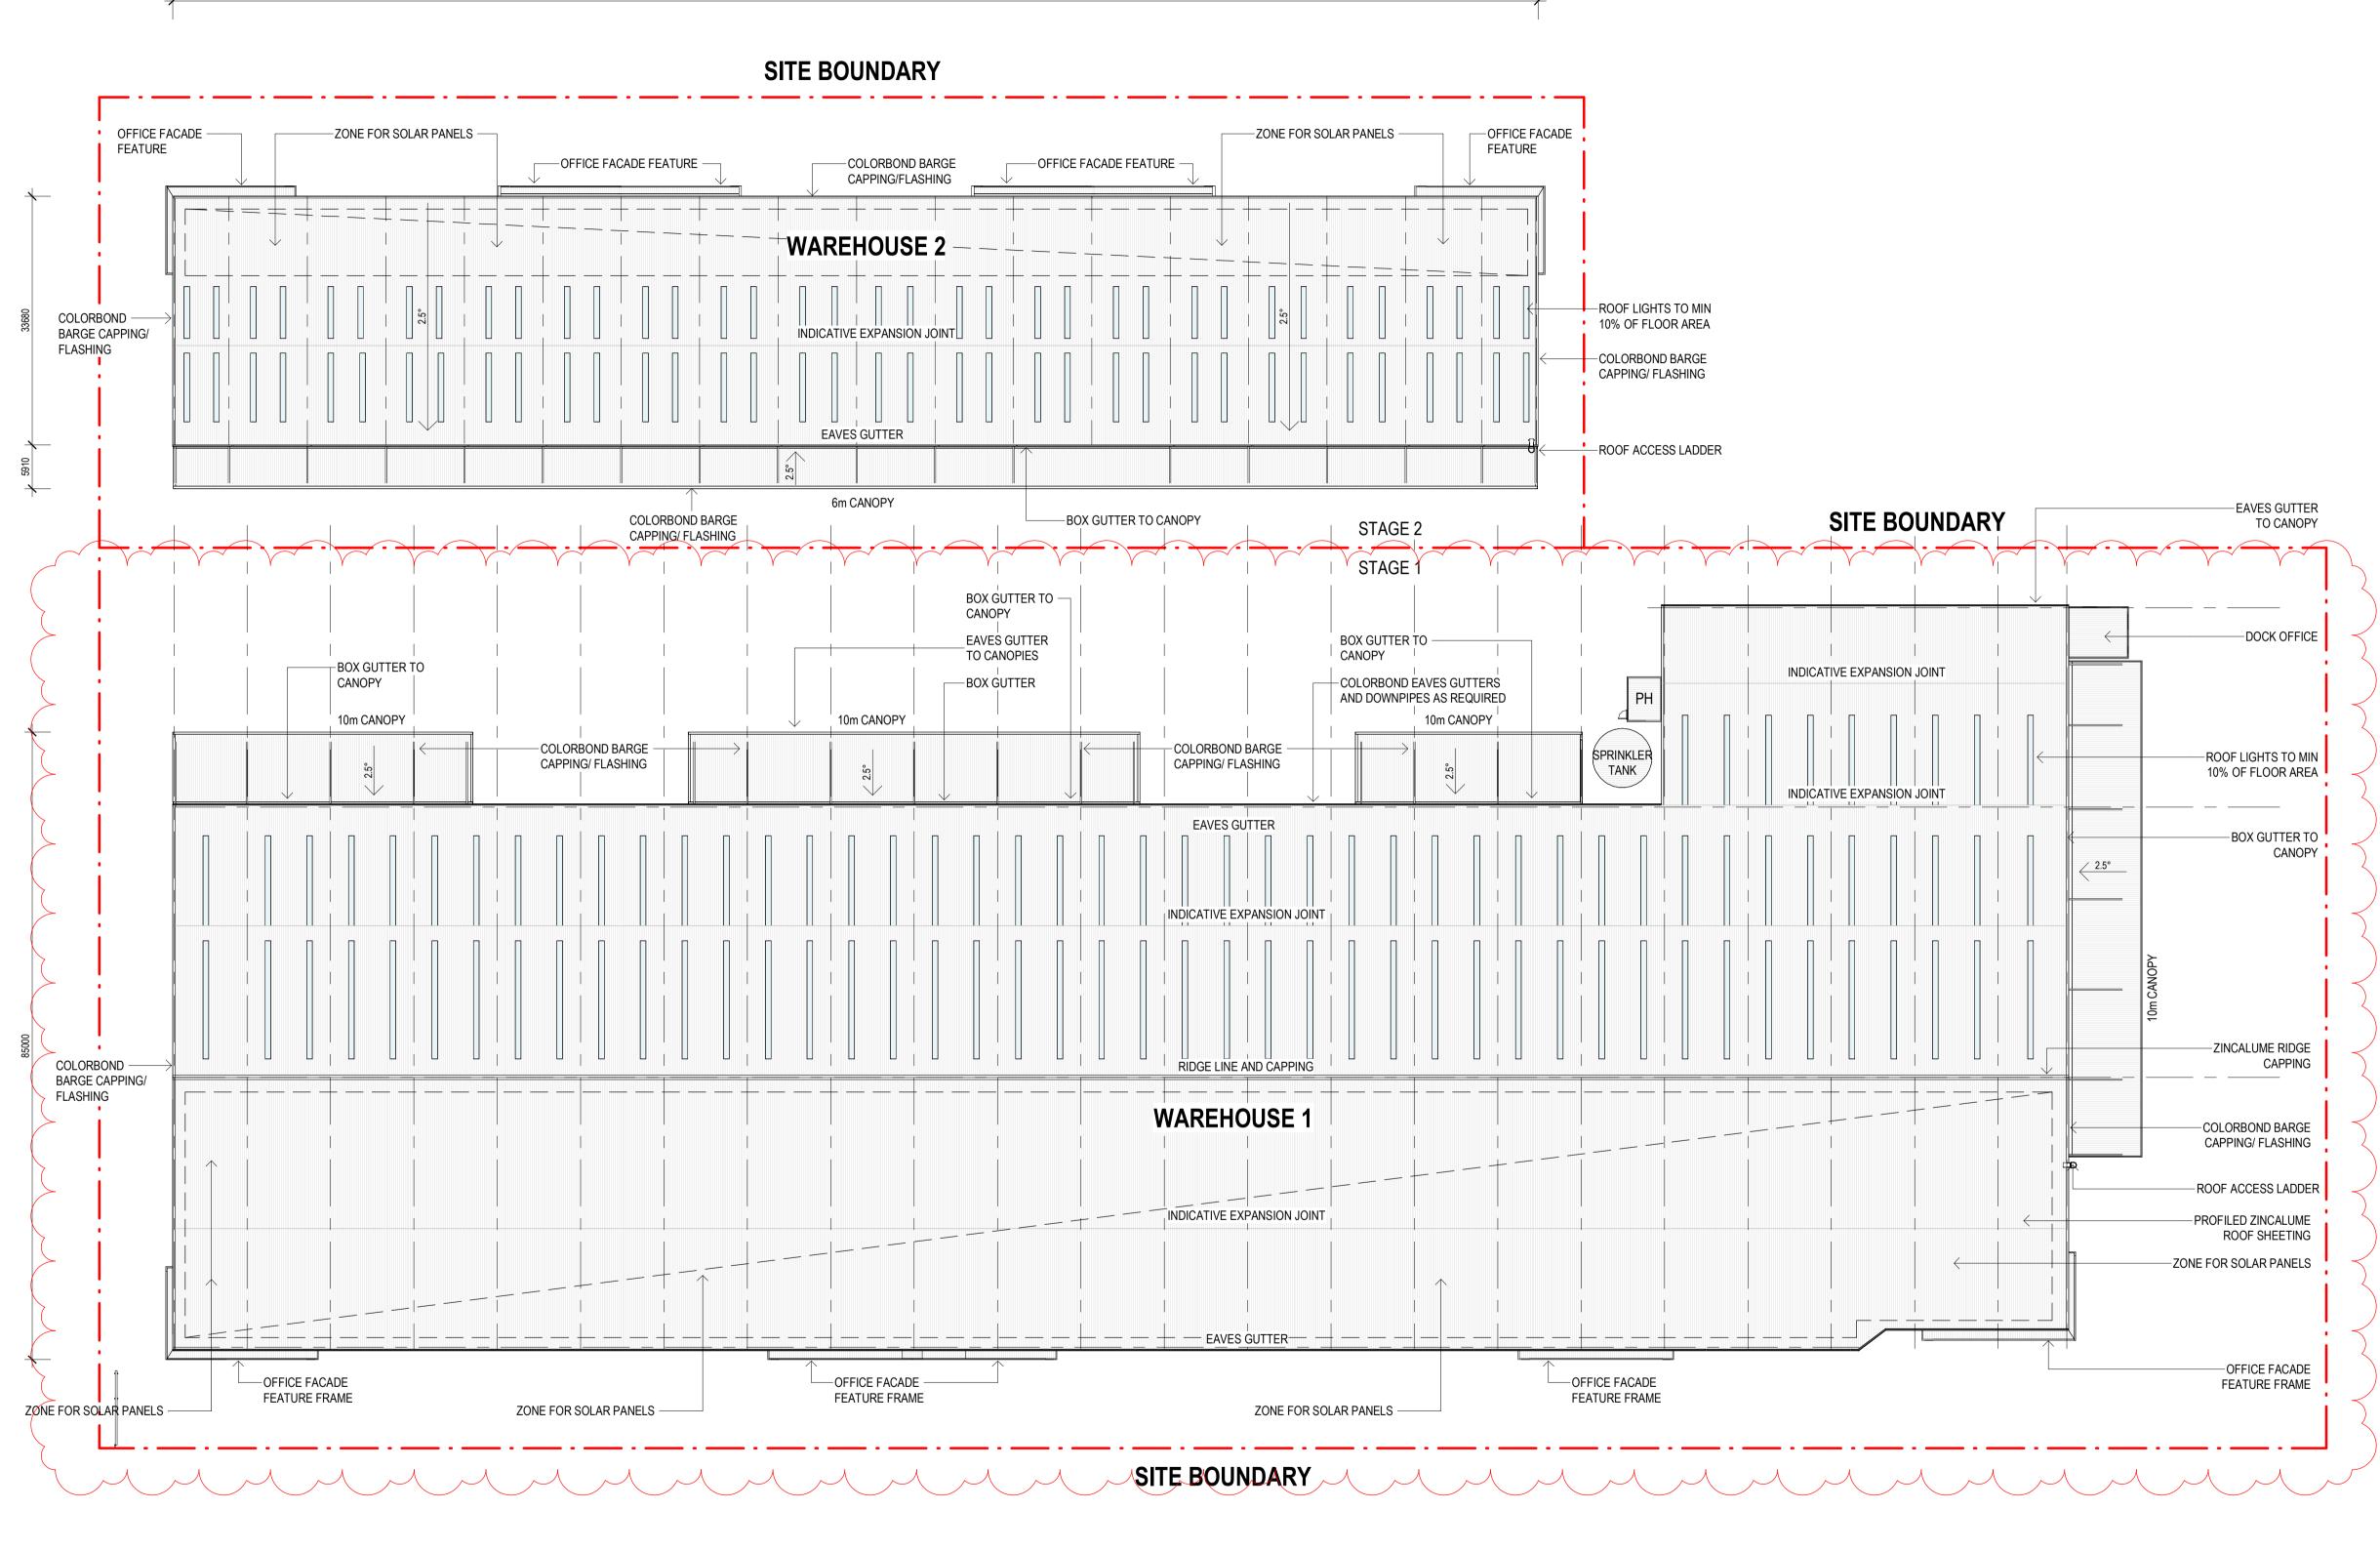ROOF PLAN
SCALE: 1:500

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D	17.05.2023	PRELIMINARY ISSUE	JG	JF
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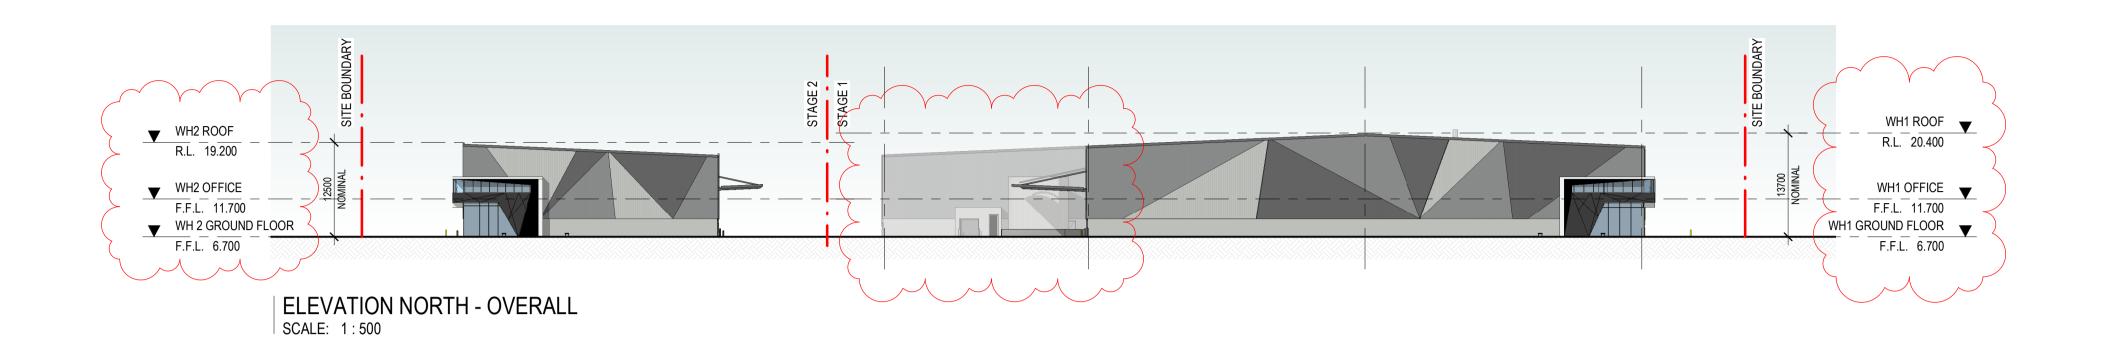
PROPOSED DEVELOPMENT
24-40 ALFRED RD, CHIPPING NORTON NSW 2170


ROOF PLAN




DATE:	APRIL, 2023
DRAWN BY:	GJ
SCALE:	1:500@A1
SCALE:	1:1000@A3





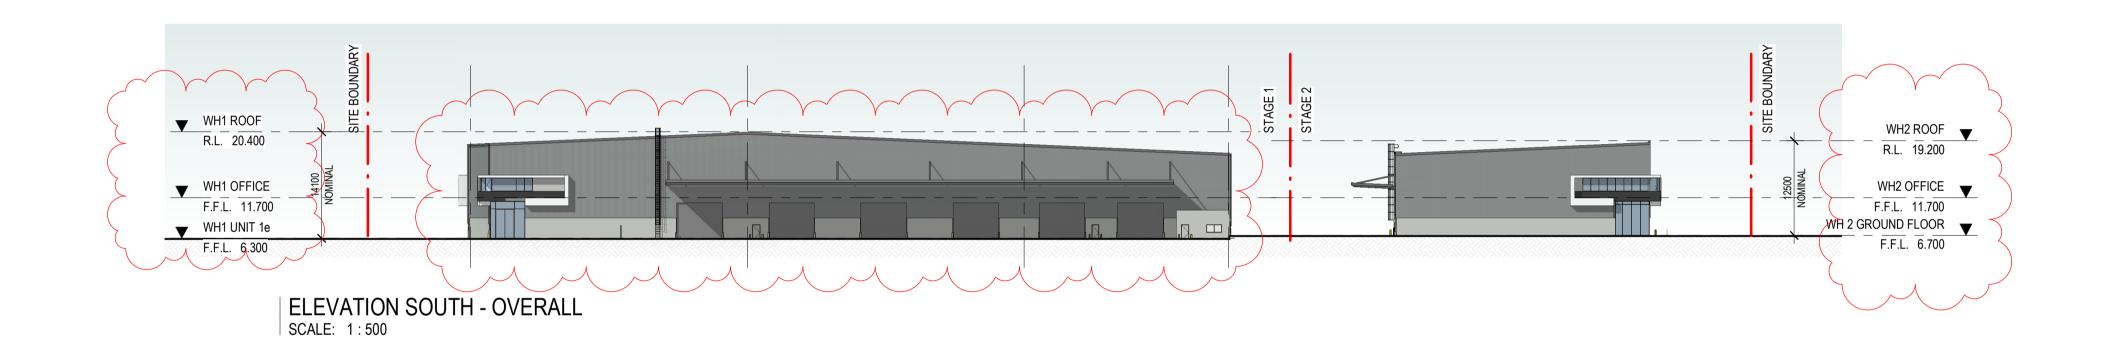

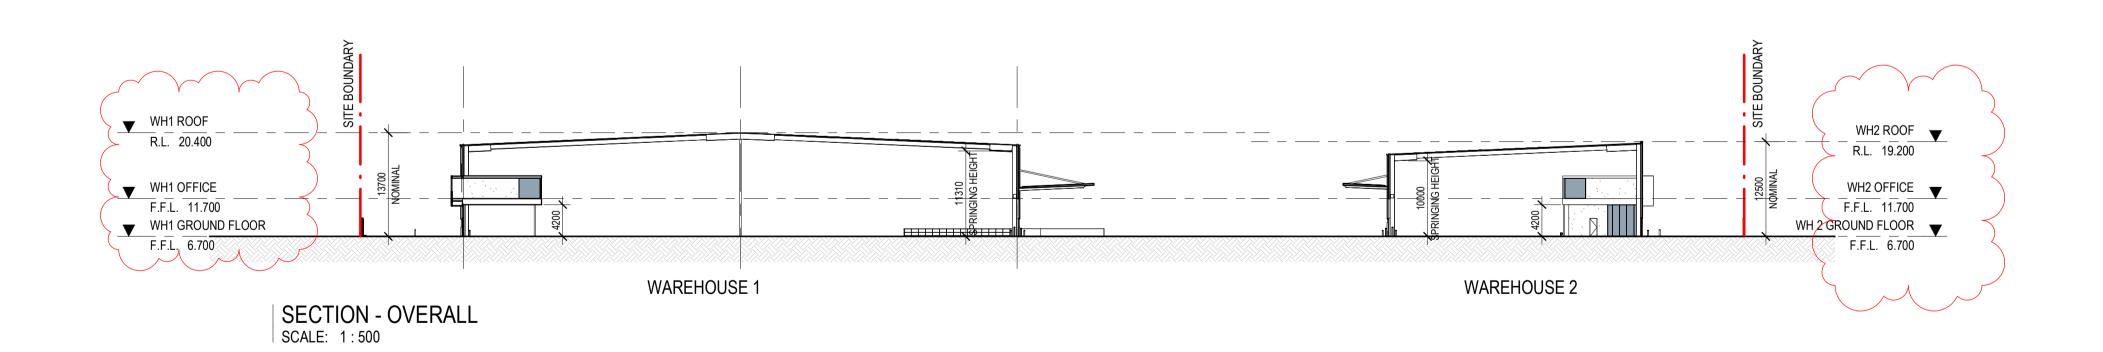

NO:	DATE:	REVISION:	BY:	CH
В	18.04.2023	ISSUED FOR APPROVAL	DM	JF
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PROPOSED DEVELOPMENT
24-40 ALFRED RD, CHIPPING NORTON NSW 2170
OVERALL


ELEVATIONS & SECTIONS OVERALL



DATE:	APRIL, 2023
DRAWN BY:	GJ
SCALE:	1:500@A1
SCALE:	1:1000@A3





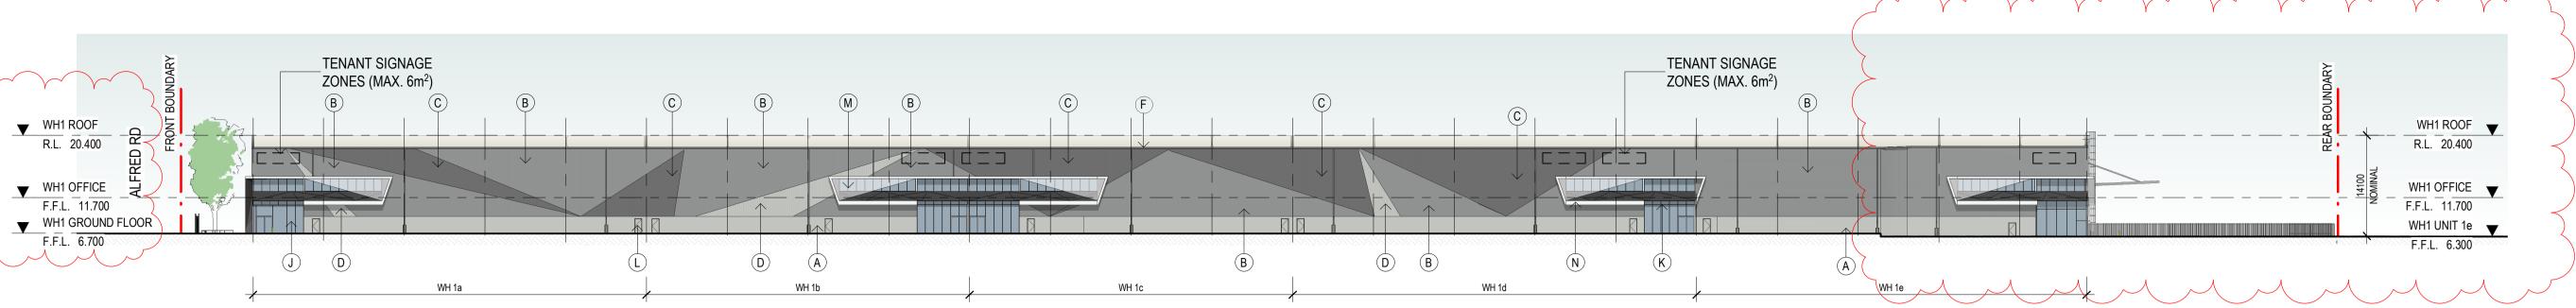

NOTES: **ELEVATION** 

ALL EXTERNAL STEELWORK EXPOSED TO THE WEATHER TO BE HOT DIPPED GALVANISED UNLESS NOTED OTHERWISE.

ALL EXTERNAL FRAMED GLAZING TO COMPLY WITH AS-1288. VISUAL INDICATORS TO COMPLY WITH AS-1428.1-2009. THE BUILDER IS TO PROVIDE A THERMAL ASSESSMENT ON ALL GLAZING USING LIGHT COLOURED VENETIAN BLINDS IN ASSESSMENT. INCLUDE ALL

ALL FLASHINGS & CAPPINGS TO BE COLORBOND WHERE VISIBLE, ZINCALUME ELSEWHERE. WITH POWDERCOATED ALUMINIUM FRAMING -REFER SCHEDULE.

ALLOWANCES TO MEET THERMAL ASSESSMENT FINDINGS.

**EXTERNAL FINISHES** 

PRECAST CONCRETE

PANEL, PAINT FINISH

CLADDING

**ROOF CLADDING** 

CLEAR GLAZING

DOOR FRAMES

PA DOOR EXTERNAL

PERFORATED METAL

SHADING MECHANISM - WHITE

ALUMINIUM CLADDING

INSTALL COLORBOND WEATHER SHIELD OVER ALL ESCAPE DOORS THAT ARE EXPOSED TO THE ELEMENTS AS DETAILED.

CONFIRM ALL DIMENSIONS AND CONDITIONS ON SITE AND PROVIDE SHOP DRAWINGS FOR APPROVAL PRIOR TO MANUFACTURING GLAZING. BUILDER AND ARCHITECT MUST BE CONTACTED IMMEDIATELY IF THERE ARE ANY DISCREPANCIES.

COLORBOND

SHALE GREY COLORBOND WINDSPRAY COLORBOND BASALT

COLORBOND

SHALE GREY

COLORBOND

COLORBOND

DARK GREY

DARK GREY

COLORBOND

SHALE GREY

TRANSPARENT -


LOW REFLECTIVITY


**BASALT** 

BLACK


SURFMIST

**ELEVATION WEST - WAREHOUSE 1** SCALE: 1:500

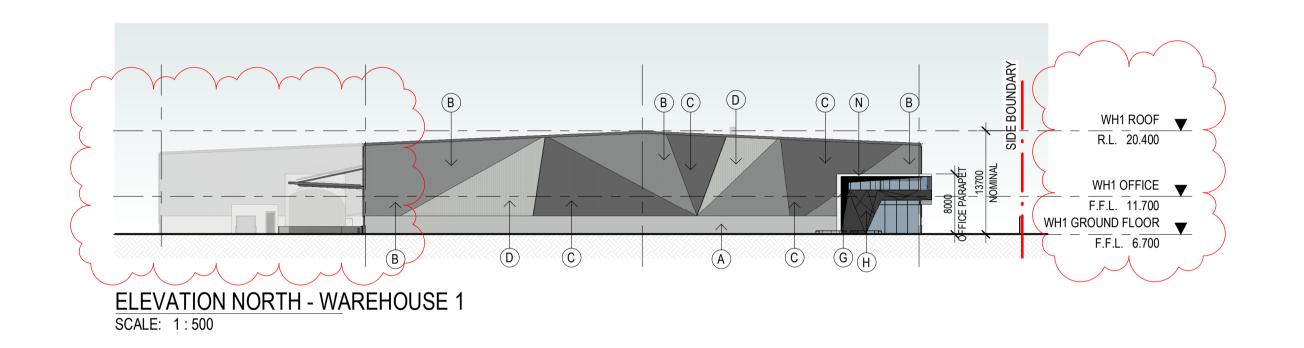

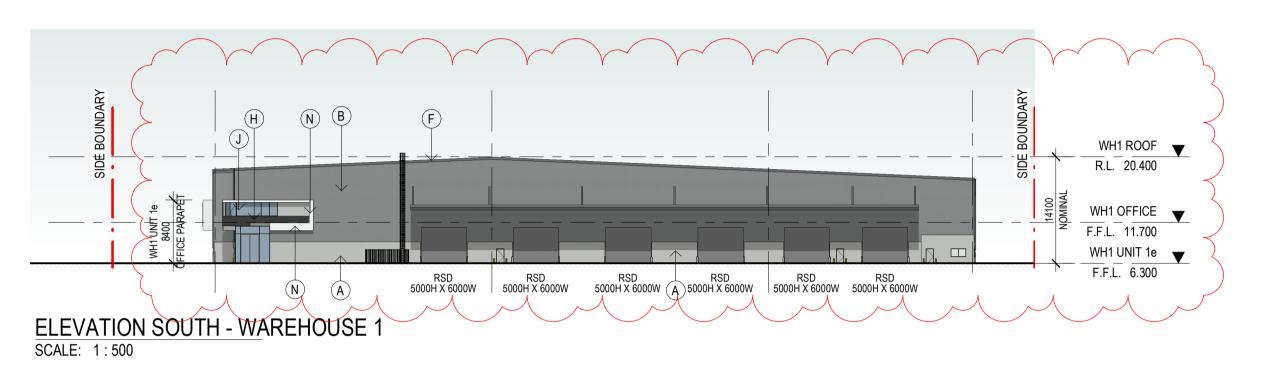

ALUMINIUM CLADDING LIGHT GREY WH1 ROOF R.L. 20.400 WH1 OFFICE F.F.L. 11.700 WH1 GROUND FLOOR F.F.L. 6.700 RSD RSD RSD 2400H X 2400W 5000H X 6000W 5000H X 6000W RSD RSD RSD S000H X 6000W 5000H X 6000W 5000H X 6000W RSD RSD RSD S000H X 6000W 5000H X 6000W RSD RSD 6000H X 9500W 6000H X 9500W RSD RSD 6000H X 9500W 6000H X 9500W ELEVATION EAST - WAREHOUSE SCALE: 1:500

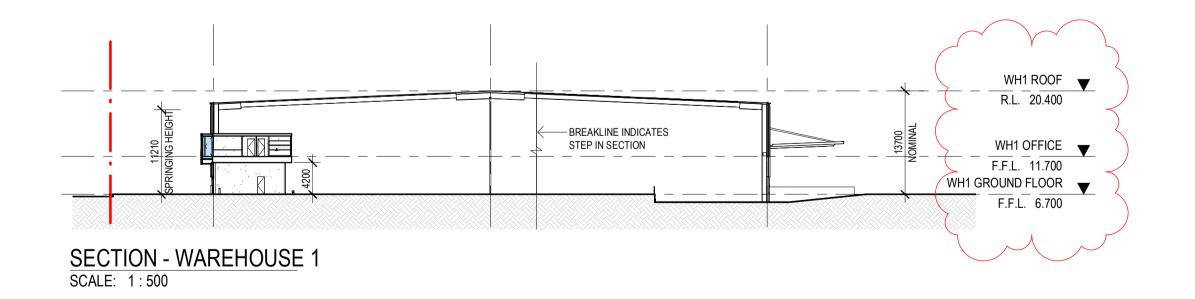

NO:	DATE:	REVISION:	BY:	CHŁ
В	18.04.2023	ISSUED FOR APPROVAL	DM	JF
С	26.04.2023	ISSUED FOR APPROVAL	JG	JF
D	17.05.2023	PRELIMINARY ISSUE	JG	JF
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PROPOSED DEVELOPMENT 24-40 ALFRED RD, CHIPPING NORTON NSW 2170


**ELEVATIONS & SECTIONS -**WAREHOUSE 1




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DRAWN BY:	GJ
SCALE:	1:500@A1
SCALE:	1:1000 @A3


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GJ	2142	20
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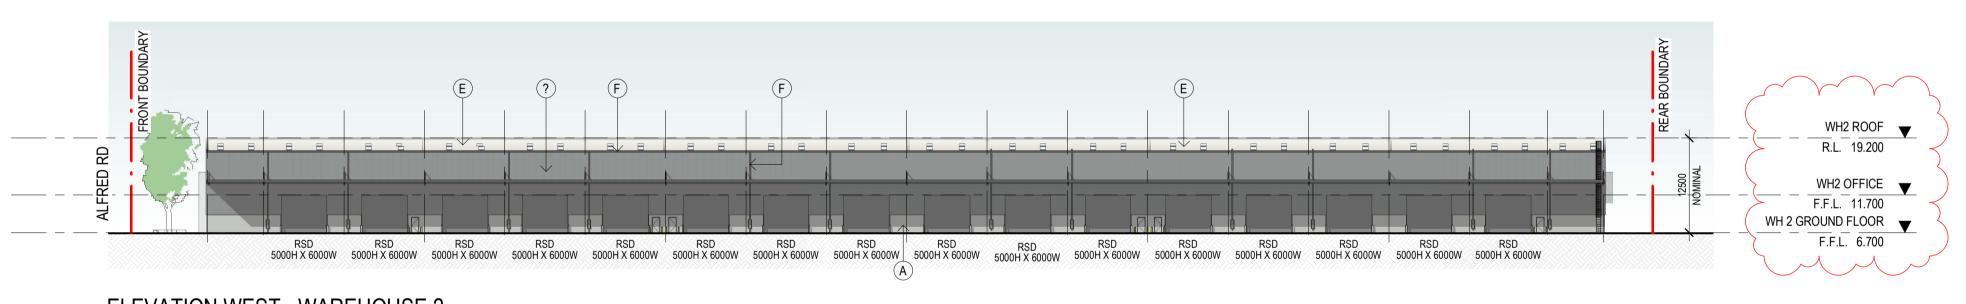


**ELEVATION EAST - WAREHOUSE 2** SCALE: 1:500

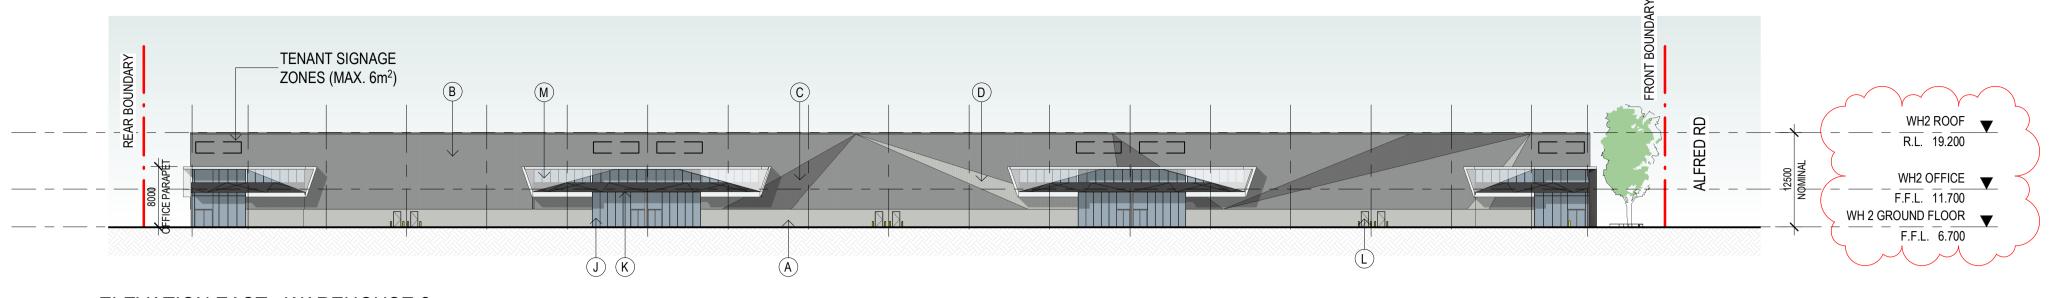


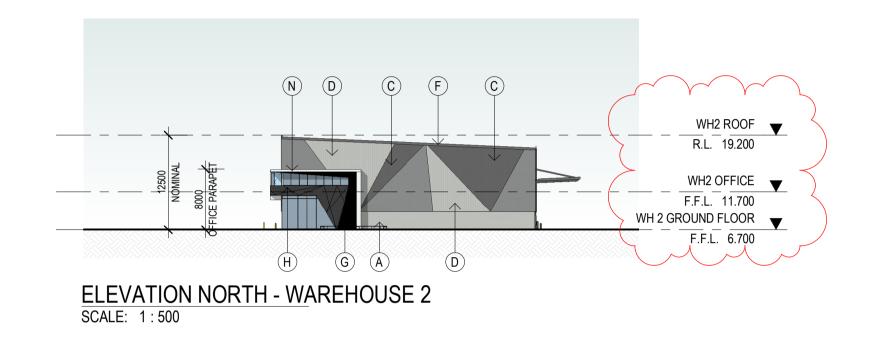

**ELEVATION SOUTH - WAREHOUSE 2** SCALE: 1:500

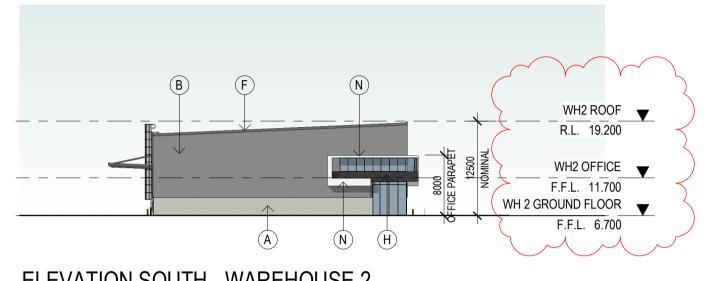

**ELEVATION WEST - WAREHOUSE 2** SCALE: 1:500

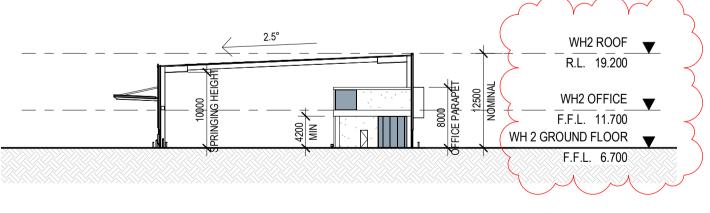

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NOTES:

REFER SCHEDULE.

DISCREPANCIES.

GALVANISED UNLESS NOTED OTHERWISE.

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ALLOWANCES TO MEET THERMAL ASSESSMENT FINDINGS.

ARE EXPOSED TO THE ELEMENTS AS DETAILED.

ALL FLASHINGS & CAPPINGS TO BE COLORBOND WHERE VISIBLE, ZINCALUME ELSEWHERE. WITH POWDERCOATED ALUMINIUM FRAMING -

**ELEVATION** 

ALL EXTERNAL STEELWORK EXPOSED TO THE WEATHER TO BE HOT DIPPED

THE BUILDER IS TO PROVIDE A THERMAL ASSESSMENT ON ALL GLAZING USING LIGHT COLOURED VENETIAN BLINDS IN ASSESSMENT. INCLUDE ALL

INSTALL COLORBOND WEATHER SHIELD OVER ALL ESCAPE DOORS THAT

CONFIRM ALL DIMENSIONS AND CONDITIONS ON SITE AND PROVIDE SHOP

DRAWINGS FOR APPROVAL PRIOR TO MANUFACTURING GLAZING. BUILDER

AND ARCHITECT MUST BE CONTACTED IMMEDIATELY IF THERE ARE ANY

**EXTERNAL FINISHES** 

PRECAST CONCRETE

PANEL, PAINT FINISH

COLORBOND WALL

CLADDING

CLADDING

K WINDOW /

DOOR FRAMES

CLADDING

PERFORATED METAL

ROOF CLADDING

GUTTERS, DOWNPIPES

ALUMINIUM CLADDING

ALUMINIUM CLADDING BLACK

SHADING MECHANISM - WHITE

ALUMINIUM CLADDING LIGHT GREY

COLORBOND

SHALE GREY

COLORBOND

WINDSPRAY COLORBOND

COLORBOND

SHALE GREY

COLORBOND

SURFMIST

COLORBOND

**BASALT** 

DARK GREY

DARK GREY

SHALE GREY

TRANSPARENT -


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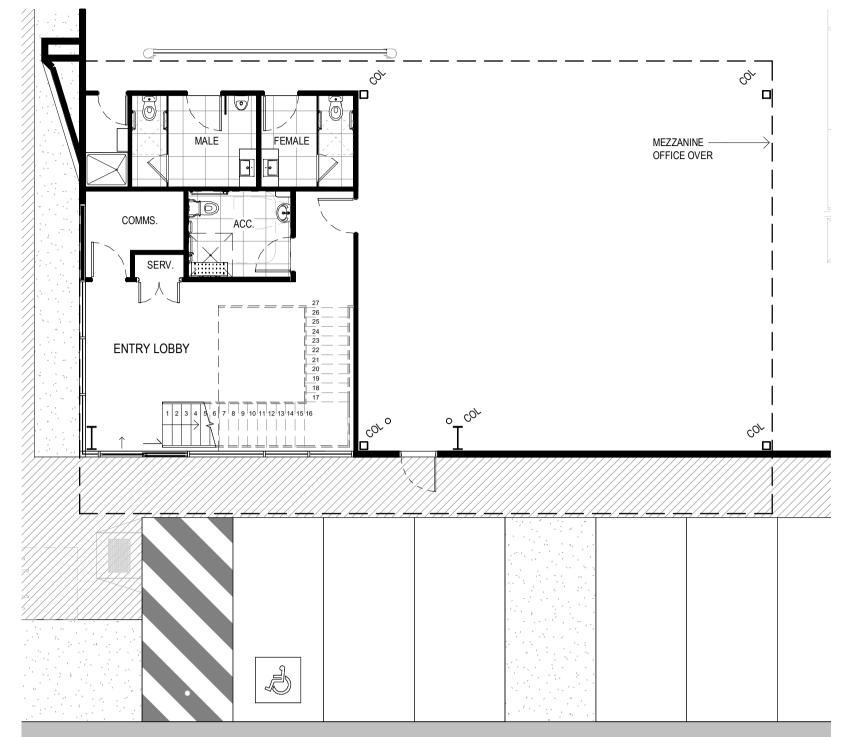
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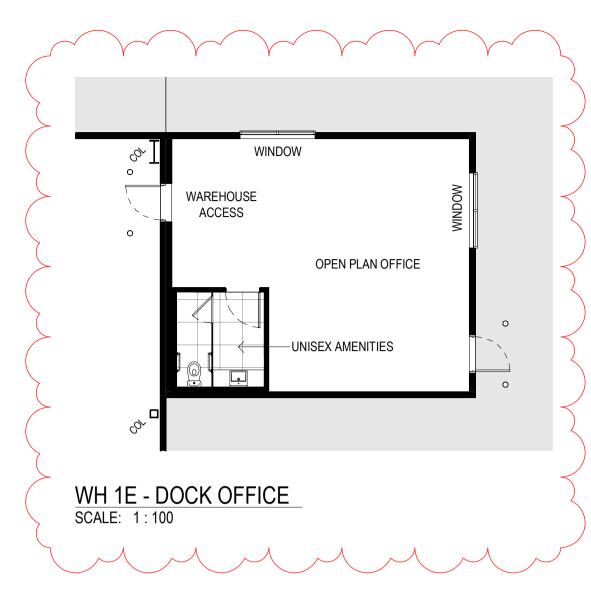


SECTION - WAREHOUSE 2 SCALE: 1:500









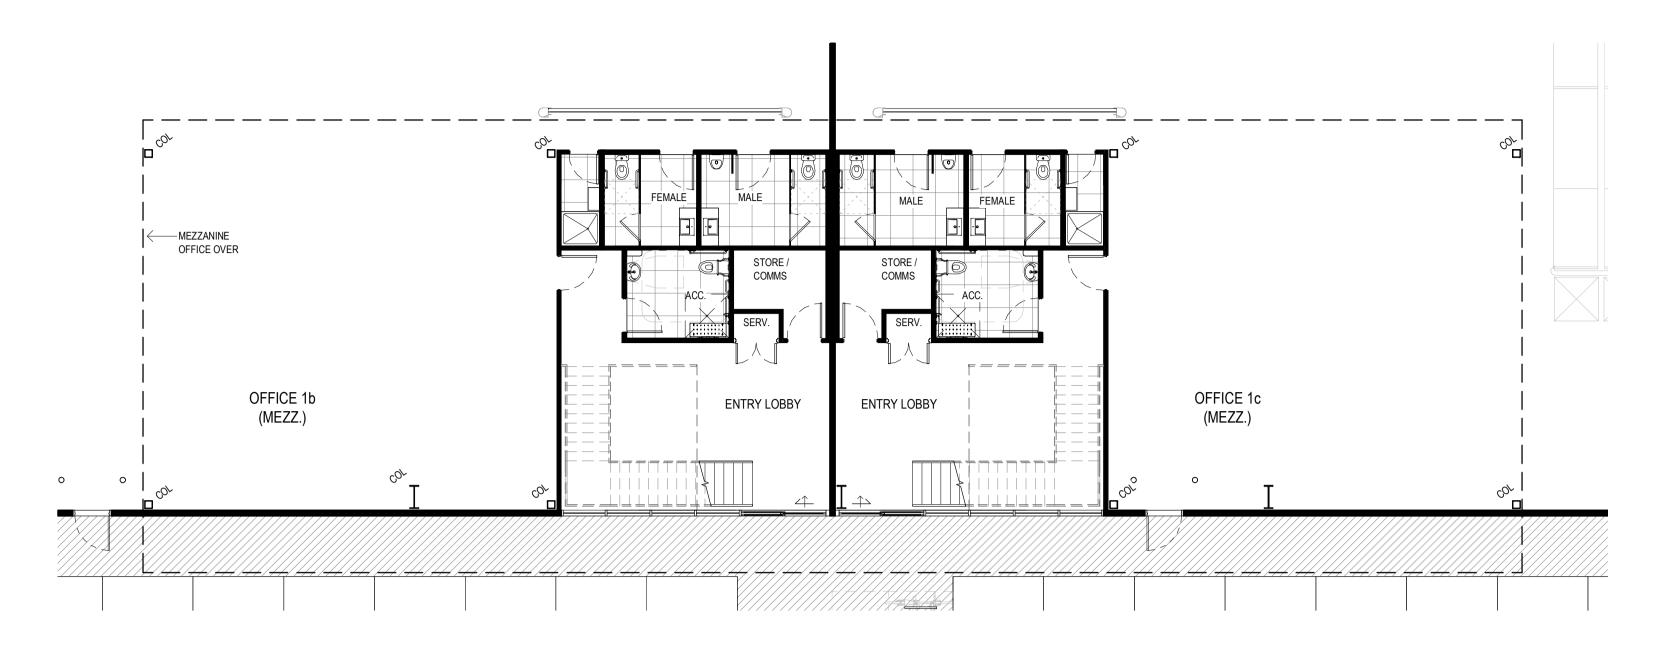

**GF OFFICE** SCALE: 1:100

GF OFFICE - CORNER SCALE: 1:100

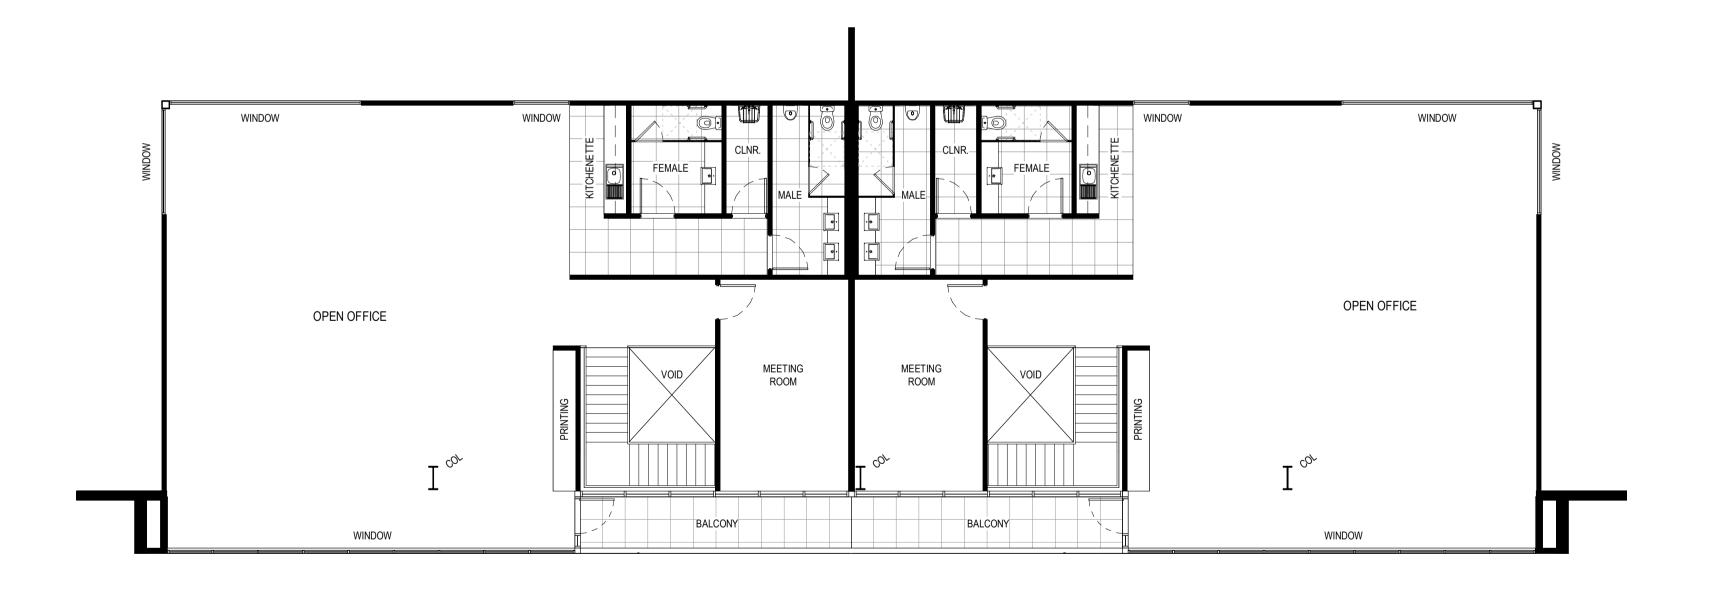

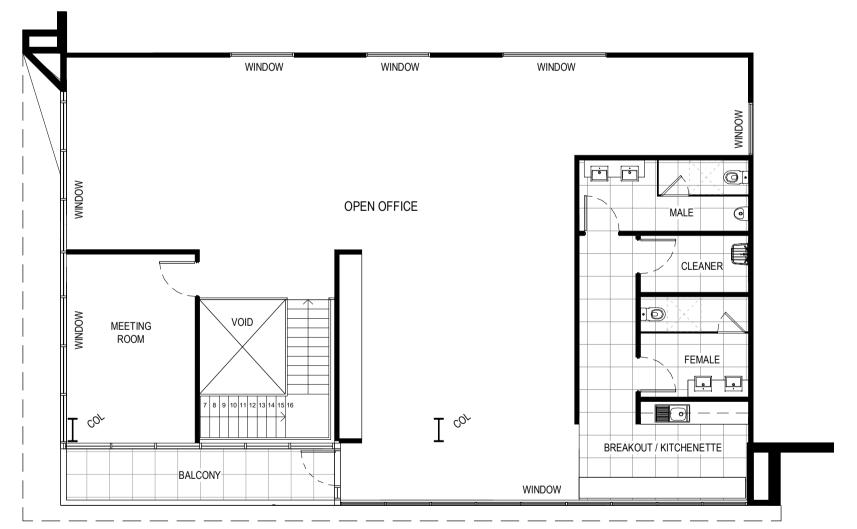

MEZZANINE OFFICE
SCALE: 1:100

MEZZANINE OFFICE - CORNER SCALE: 1:100

NO:	DATE:	REVISION:	BY:	CHK
Α	30.05.2022	ISSUED FOR APPROVAL	IO	JF
В	18.04.2023	ISSUED FOR APPROVAL	DM	JF
С	26.04.2023	ISSUED FOR APPROVAL	JG	JF
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Е	15.06.2023	ISSUED FOR LODGEMENT	JG	JF

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PROPOSED DEVELOPMENT
24-40 ALFRED RD, CHIPPING NORTON NSW 2170
PROPOSED OFFICE PLAN
TYPICAL - WAREHOUSE 1




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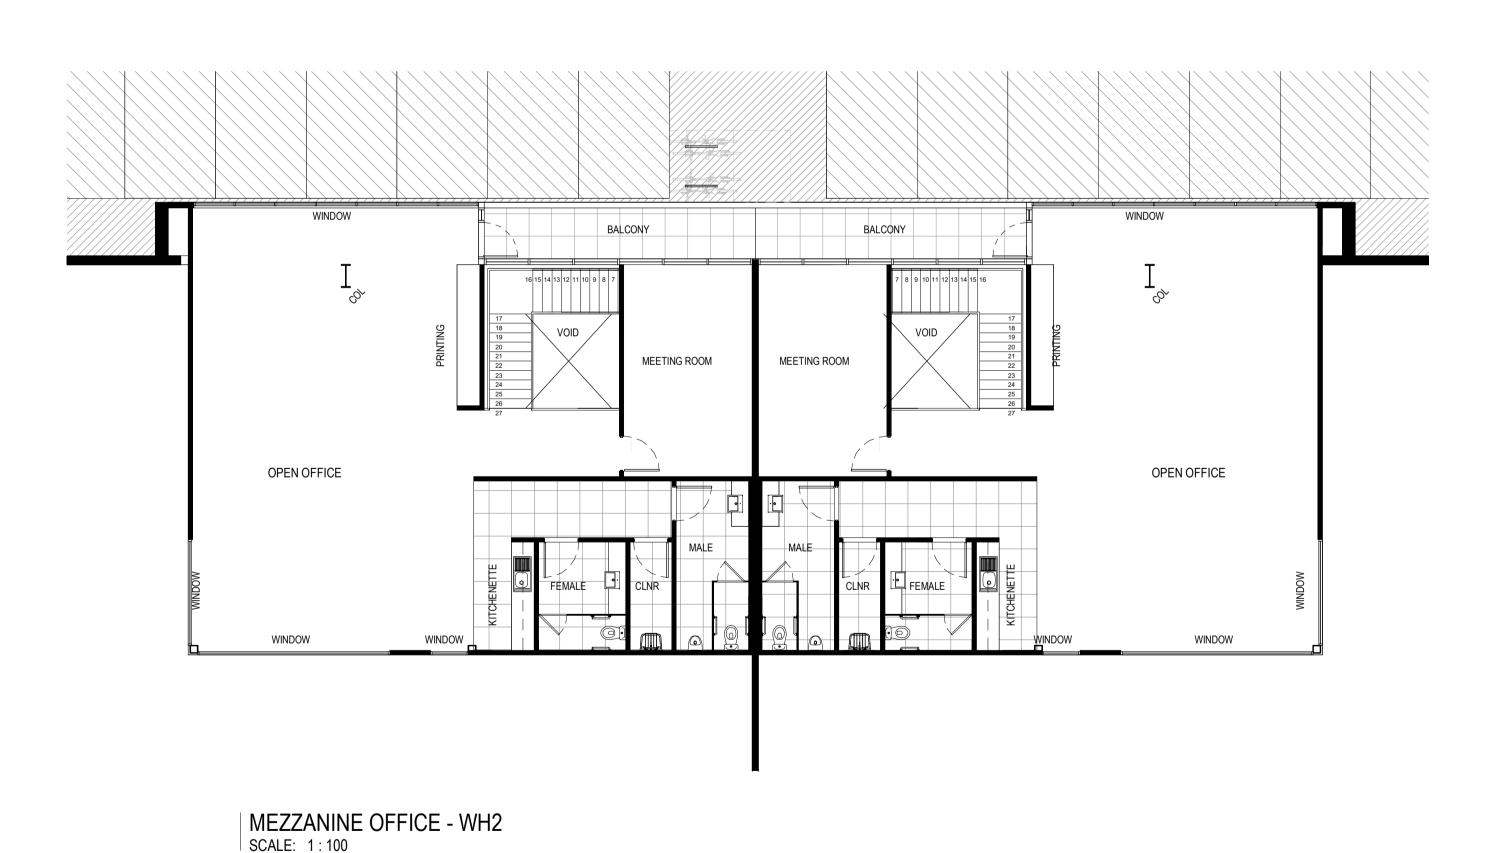
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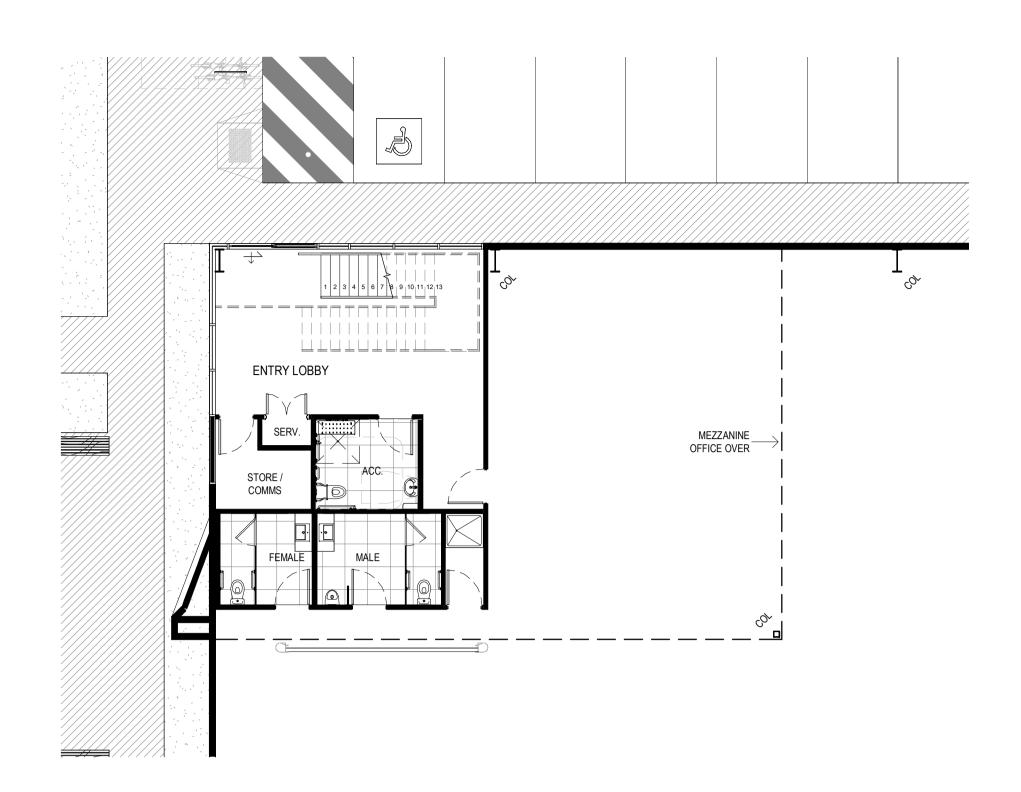
DA12

REVISION:








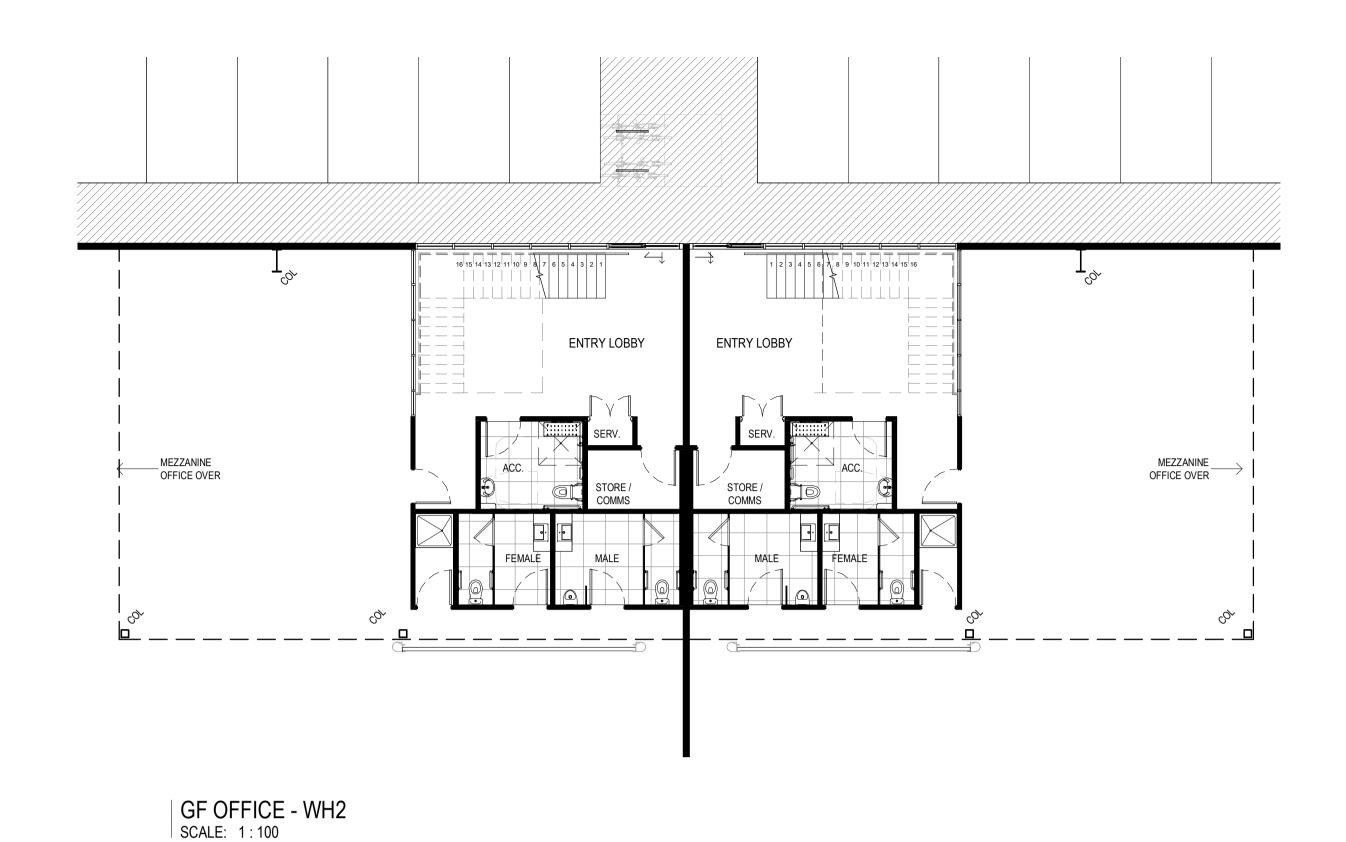

| GF OFFICE - CORNER - WH2 SCALE: 1:100

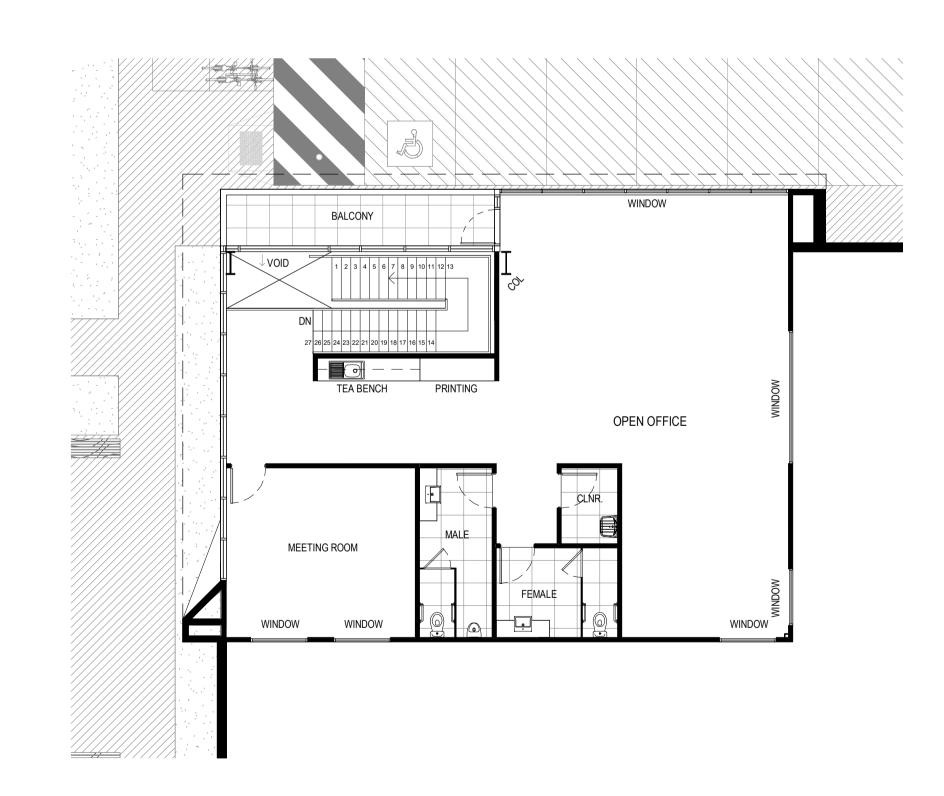

| MEZZANINE OFFICE - CORNER - WH2 SCALE: 1:100

NO:	DATE:	REVISION:	BY:	CHK
Α	30.05.2022	ISSUED FOR APPROVAL	Ю	JF
В	18.04.2023	ISSUED FOR APPROVAL	DM	JF
С	26.04.2023	ISSUED FOR APPROVAL	JG	JF
D	25.05.2023	ISSUED FOR APPROVAL	JG	JF
Е	15.06.2023	ISSUED FOR LODGEMENT	JG	JF


All areas indicated are indicative for design and planning purposes only and should not be used for any contractual reasons without verification by a licensed surveyor or further design development


Watson Young Architects P/L Melbourne | Perth | Sydney 03 9516 8555 ACN: 111398700 8 Grattan Street Prahran VIC 3181 <a href="mailto:info@watsonyoung.com.au">info@watsonyoung.com.au</a> watsonyoung.com.au © Watson Young Architects. This drawing is protected by copyright.


APRIL, 2023 1:100@A1 1:200 @A3





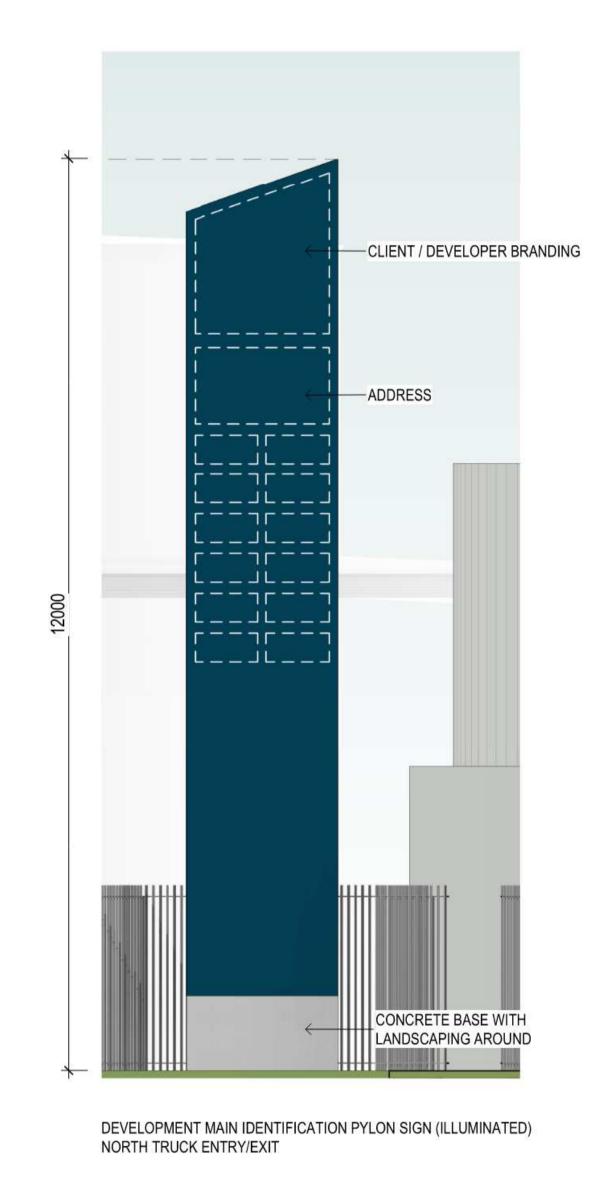

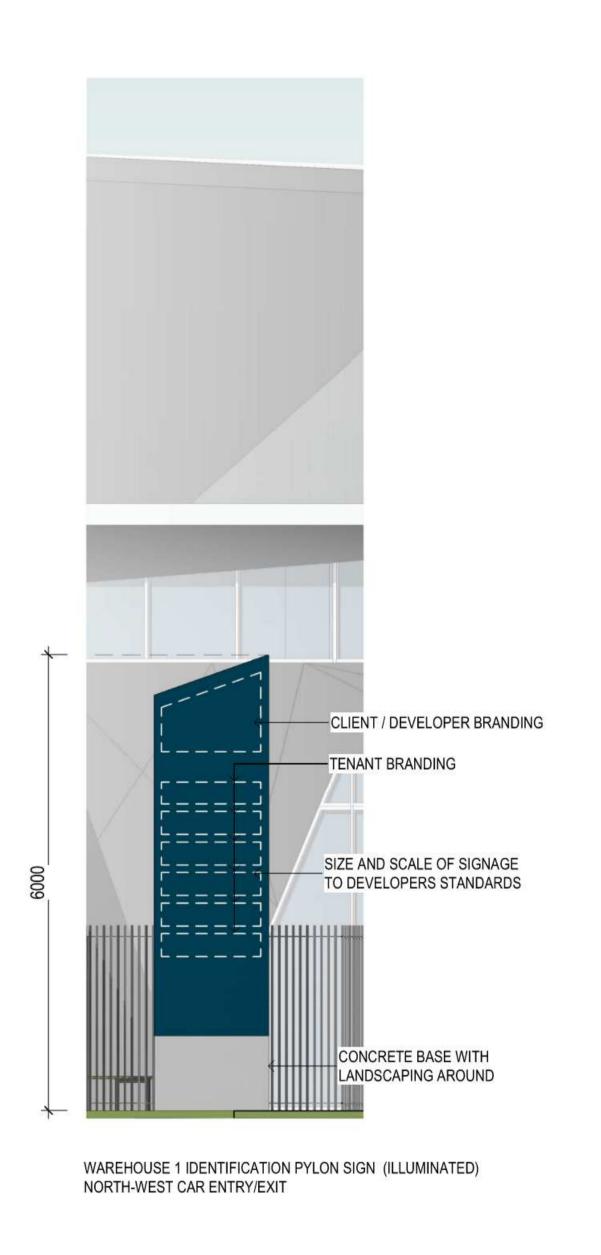

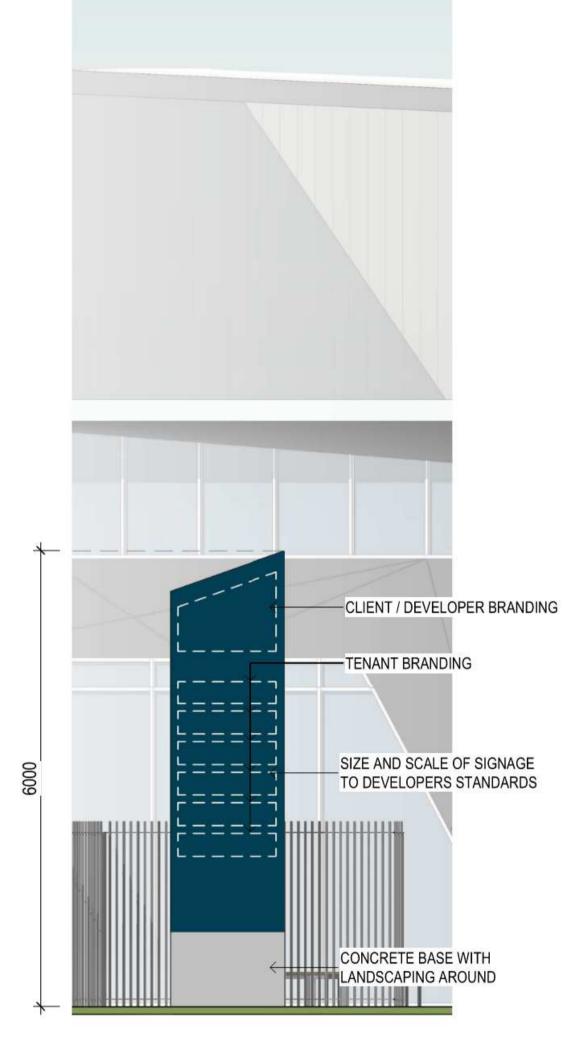

WAREHOUSE 2 IDENTIFICATION PYLON SIGN NORTH-EAST CAR ENTRY/EXIT

SCALE:

SCALE:

APRIL, 2023

NTS @A1

NTS @A3

21420

N	O:	DATE:	REVISION:	BY:	CH
	С	08.06.2022	ISSUED FOR APPROVAL	AS	JF
_	D	18.04.2023	ISSUED FOR APPROVAL	DM	JF
	Е	26.04.2023	ISSUED FOR APPROVAL	JG	JF
_	F	25.05.2023	ISSUED FOR APPROVAL	JG	JF
	G	15.06.2023	ISSUED FOR LODGEMENT	JG	JF

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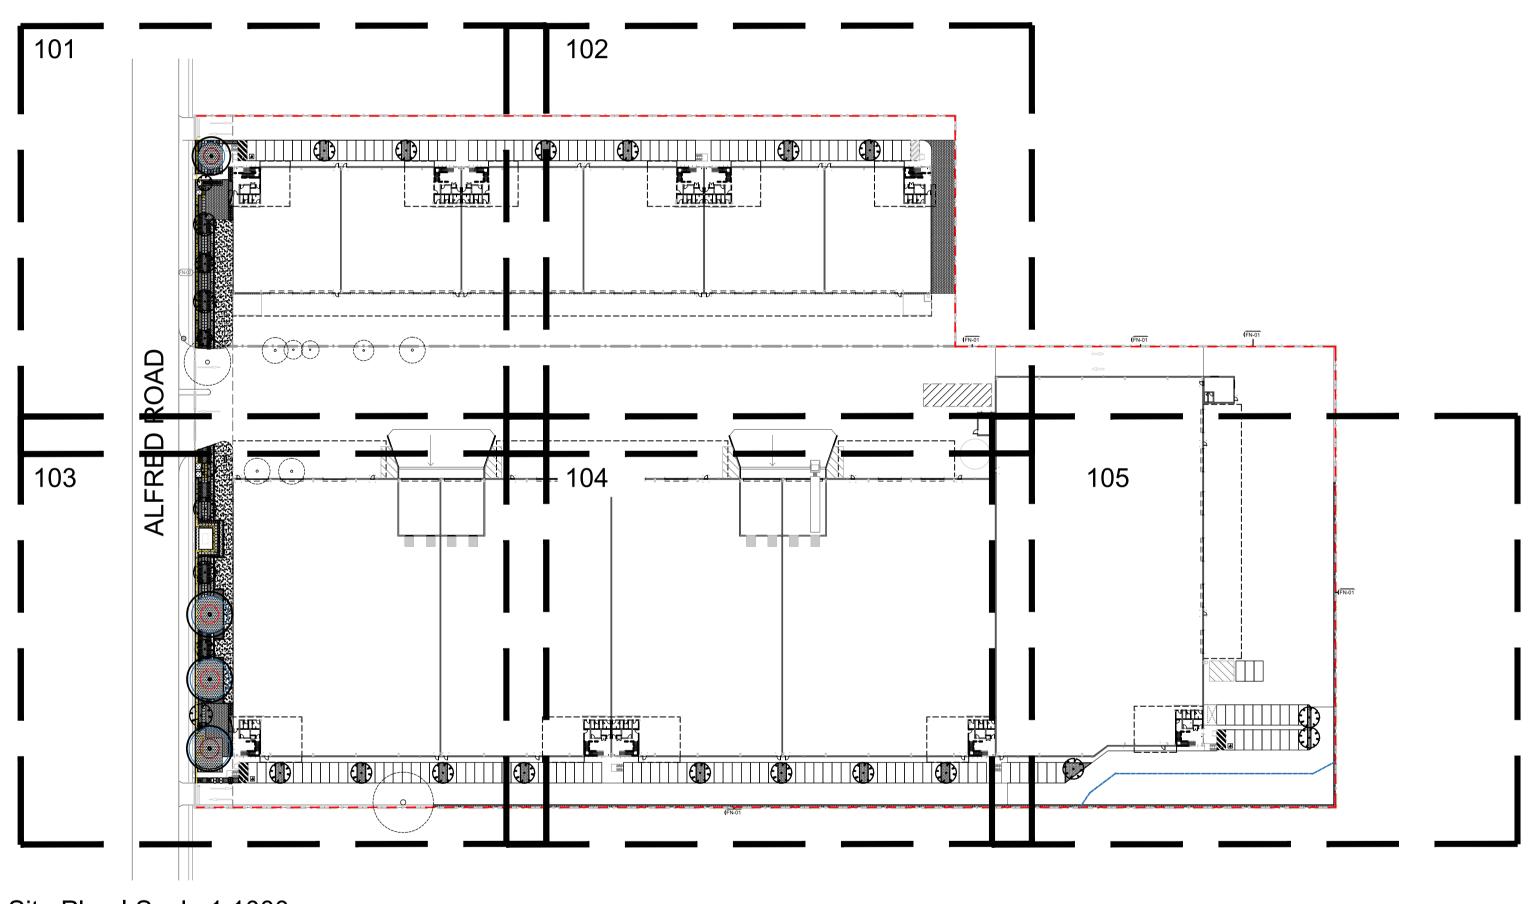
## Industrial Development

# 24-40 Alfred Road, Chipping Norton NSW 2170 Development Application

#### **Drawing Schedule**

Drawing Number	Drawing Title	Scale
000	Landscape Coversheet	N/A
101	Landscape Plan	1:200
102	Landscape Plan	1:200
103	Landscape Plan	1:200
104	Landscape Plan	1:200
105	Landscape Plan	1:200
501	Landscape Details	As Shown

	Botanic Name	Common Name	Mature Size	Native / Exotic	Pot Size	Density	Qty
GROUND F	LOOR						
TREES							
Вс	Back housia citriodora	Lemon Myrtle	20 x 5	N	100L	As Shown	2
Ca	Cupaniopsis anacardioides	Tuckeroo	8 x 7	N	100L	As Shown	17
Fg	Fraxinus griffithii	Evergreen Ash	8 x 4	E	100L	As Shown	3
TI	Tristaniopsis laurina	Water Gum	15 x 6	N	100L	As Shown	5
SHRUBS &	ACCENTS						
AsM	Acmena smithii Minor	Dwarf Lilly Pilly	3 x 2	N	300mm	As Shown	125
De	Doryanthes excelsa	Gymea Lily	2 x 2	N	300mm	As Shown	4
Мра	Murraya paniculata	Orange Jessamine	3 x 1.5	N	300mm	As Shown	20
WfZ	Westringia fruticosa 'Zena'	Coastal Rosemary	0.9 x 0.9	N	300mm	As Shown	426
GRASSES	& GROUND COVERS						
Gt	Gazania tomentosa	Silver Gazania	0.3 x 1	N	150mm	5/m2	39
LI	Lomandra longifolia	Basket Grass	1 x 0.6	N	150mm	5/m2	349
Мp	Myoporum parvifolium	Creeping Boobialla	0.3 x 2	N	150mm	5/m2	1332
PE	Poa labillardieri 'Eskdale'	Tussock Grass	0.4 x 0.4	N	150mm	5/m2	330
Ps	Pennisetum setaceum	Fountain Grass	1.5 x 1	N	150mm	5/m2	90
Та	Themeda australis	Kangaroo Grass	0.7 x 0.5	N	150mm	5/m2	79
Tj	Trachelospermum jasminoides	Star Jasmine	0.5 x 1	Е	150mm	5/m2	328



Site Plan | Scale 1:1000

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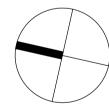
The contractor shall check and verify all work on site (including work by others) before commencing the landscape installation. Any discrepancies are to be reported to the Project Manager or Landscape Architect prior to commencing work. Do not scale this drawing. Any required dimensions not shown shall be referred to the Landscape Architect for confirmation.

I	Architectural Coordination	CS	NM	04.05.2023
Н	Architectural Coordination	CS	NM	02.05.2023
G	Architectural Coordination	CS	NM	20.04.2023
F	Architectural Coordination	CS	NM	19.04.2023
Ε	Refer to Comments	RH	NM	09.06.2022
D	Address Updated	RH	NM	27.05.2022
С	Architectural Coordination	RH	NM	26.05.2022
В	Architectural Coordination	RH	NM	06.05.2022
Α	For Comment	RH	NM	16.03.2022

Drawn Check Dat

Legend

Issue Revision Description



Aliro A

24-40 Alfred Road
Chipping Norton
NSW 2170

Level 1, 3-5 Baptist Street Redfern NSW 2016

Australia

Tel: (61 2) 8332 5600

Fax: (61 2) 9698 2877

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**PRELIMINARY** 

Drawing Name

Landscape Coversheet


Scale

Daniel a Newsbar


awing Number

000

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The contractor shall check and verify all work on site (including work by others) before commencing the landscape installation. Any discrepancies are to be reported to the Project Manager or Landscape Architect prior to commencing work. Do not scale this drawing. Any required dimensions not

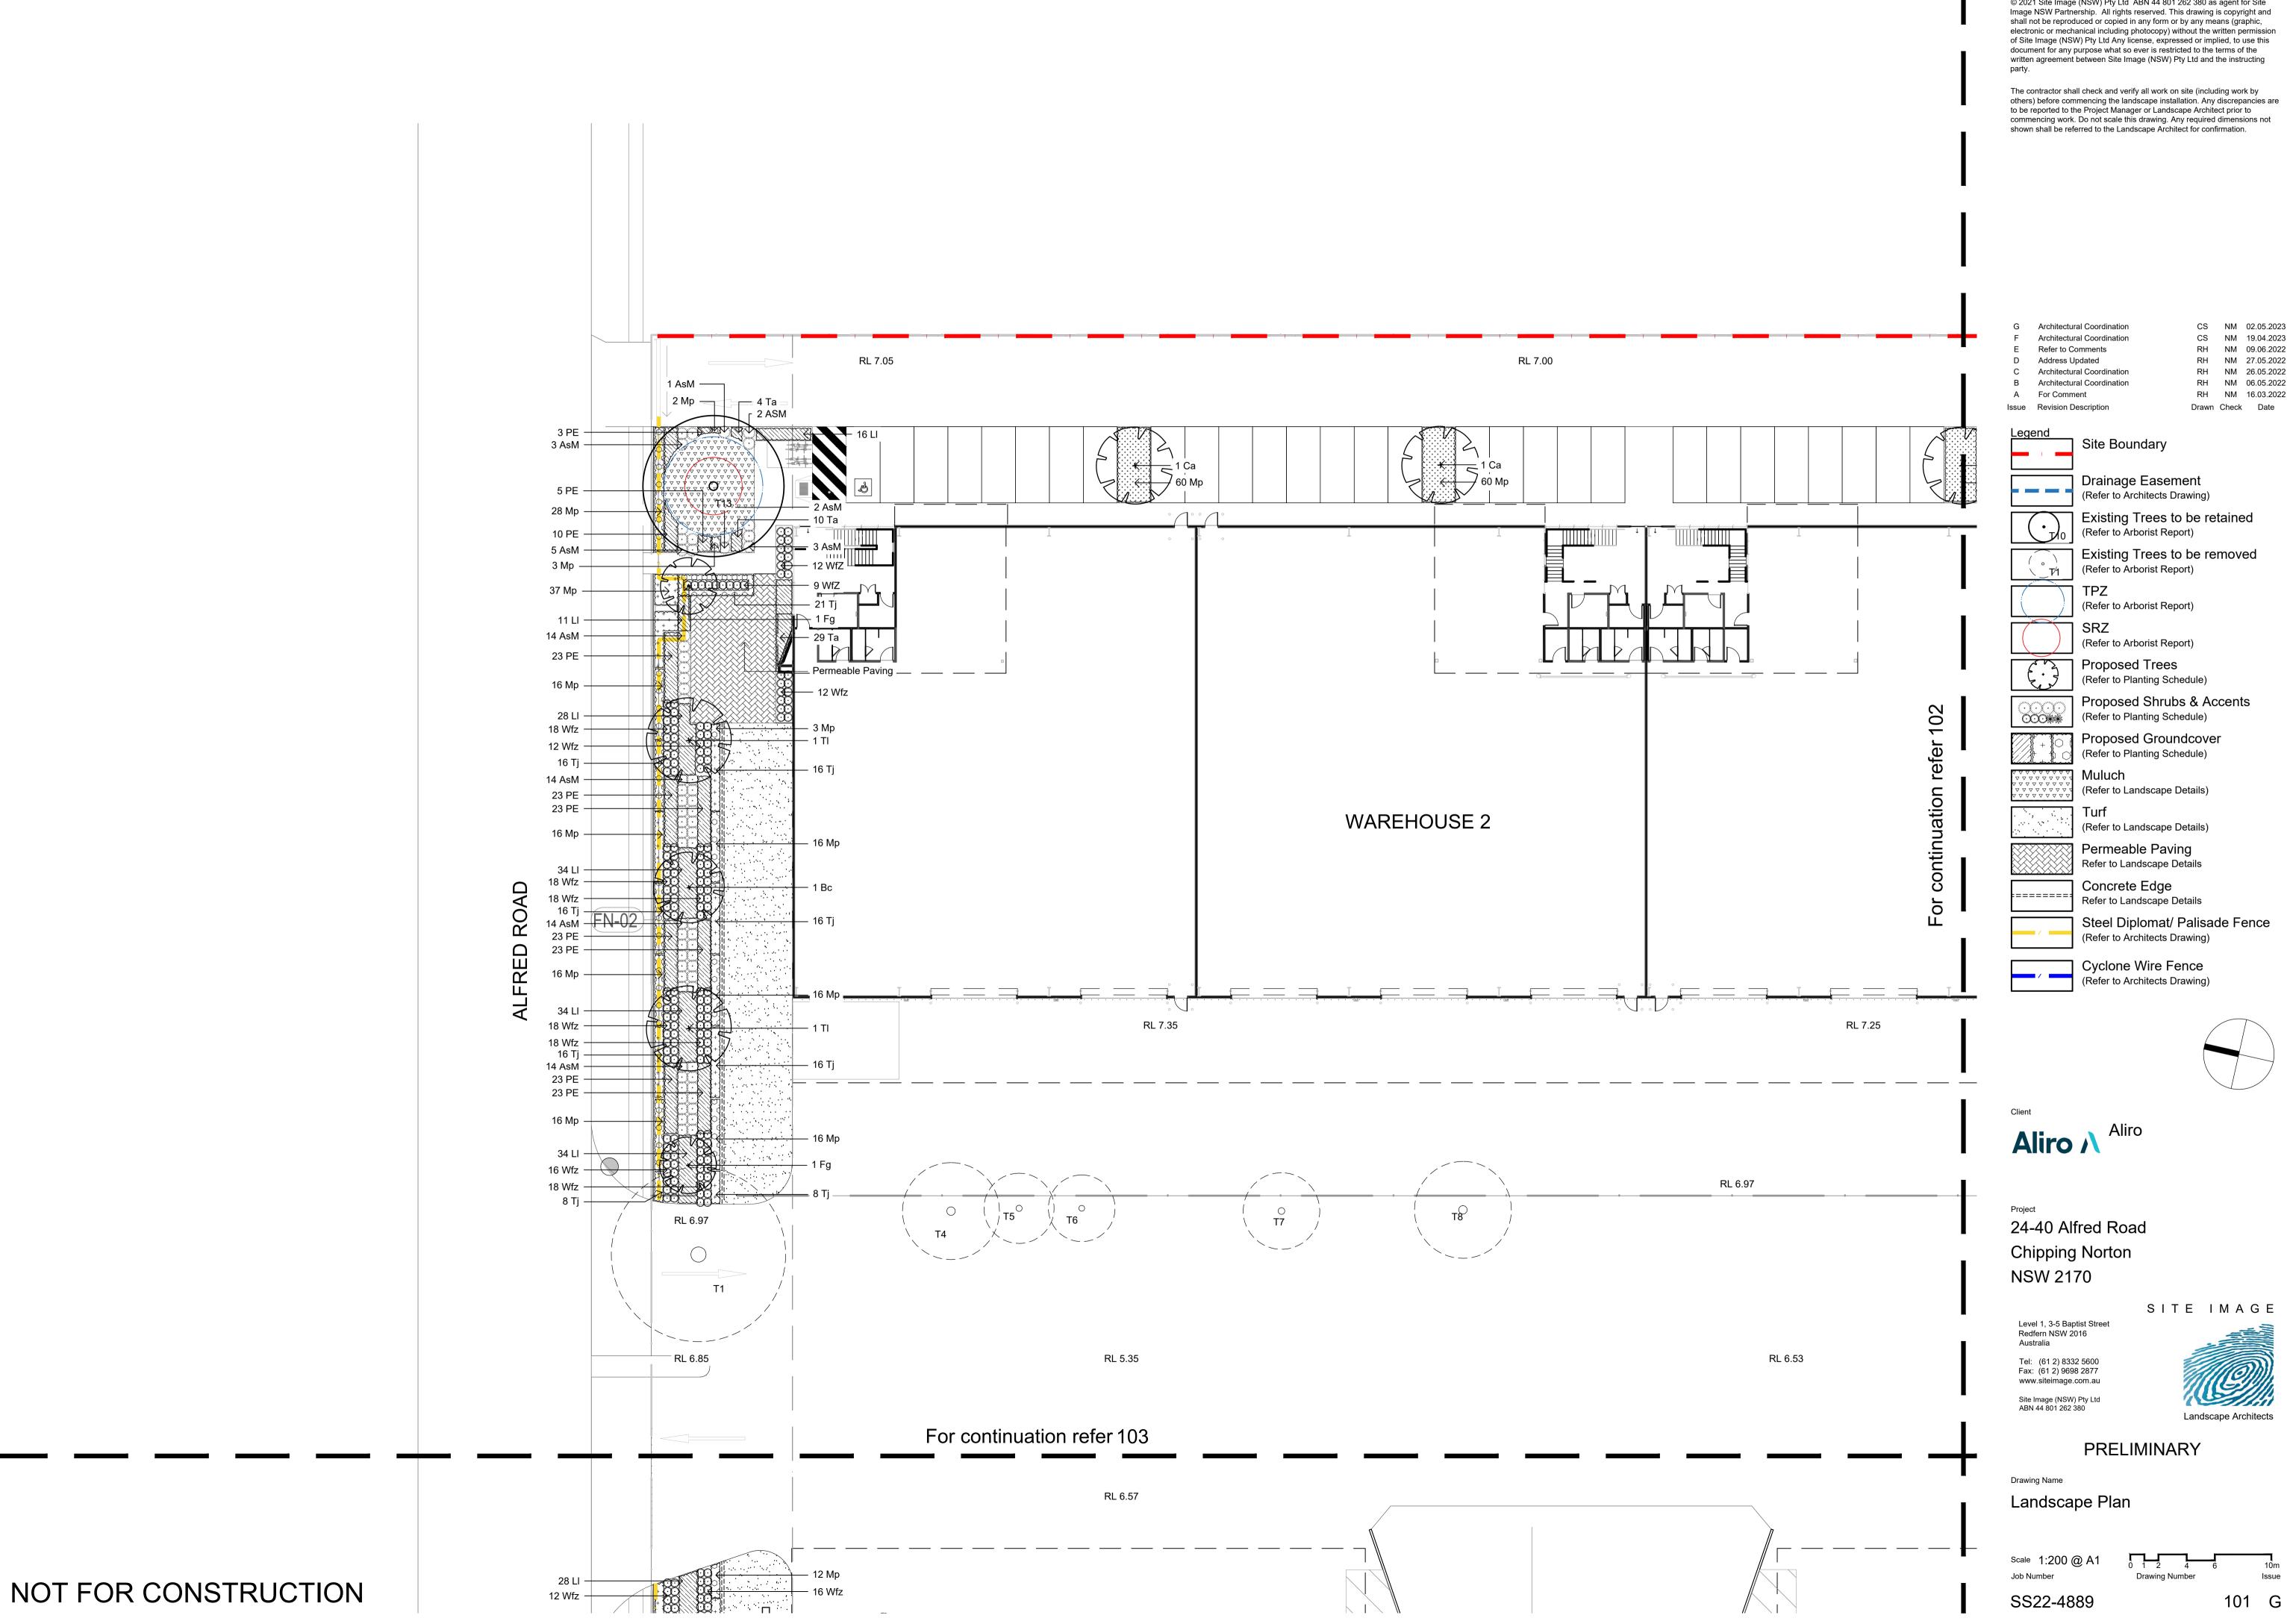CS NM 02.05.2023 CS NM 19.04.2023 RH NM 09.06.2022 RH NM 27.05.2022 RH NM 26.05.2022 RH NM 06.05.2022 RH NM 16.03.2022 Drawn Check Date Drainage Easement (Refer to Architects Drawing) Existing Trees to be retained (Refer to Arborist Report)

(Refer to Planting Schedule)

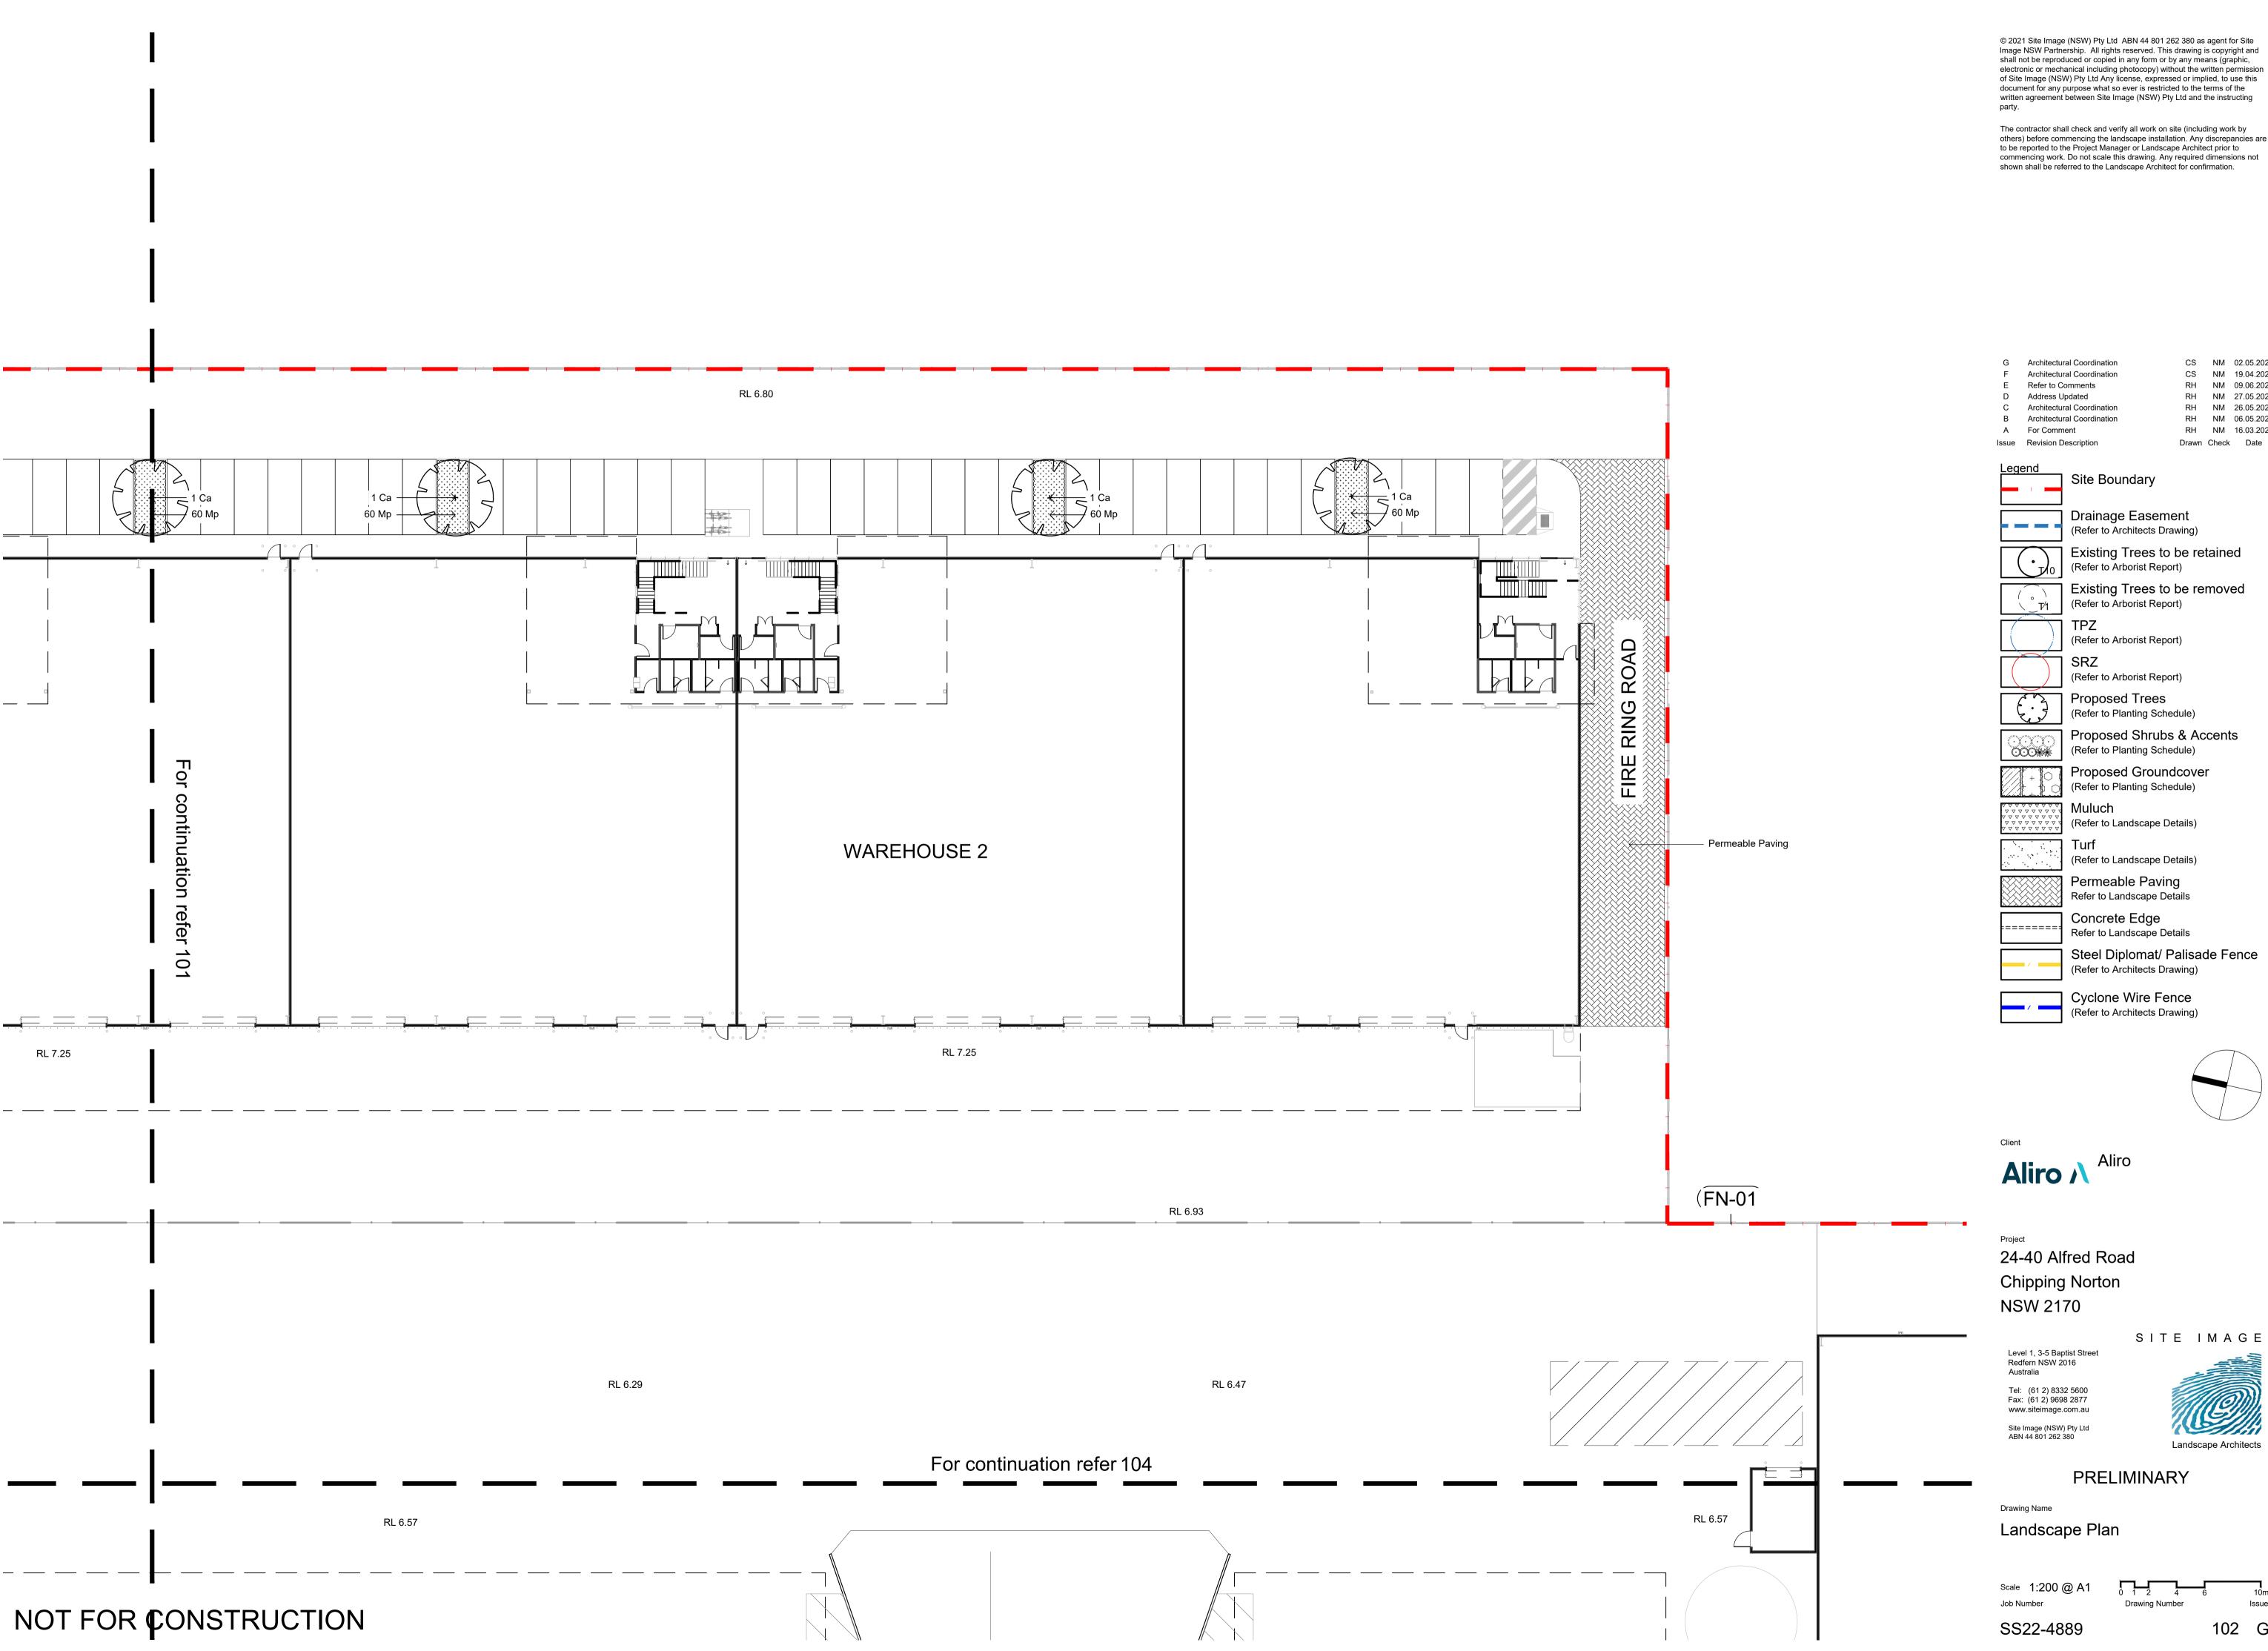
Proposed Groundcover (Refer to Planting Schedule)

Permeable Paving Refer to Landscape Details

Refer to Landscape Details

Steel Diplomat/ Palisade Fence (Refer to Architects Drawing)


Cyclone Wire Fence

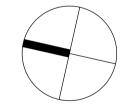





Drawing Number

102 G

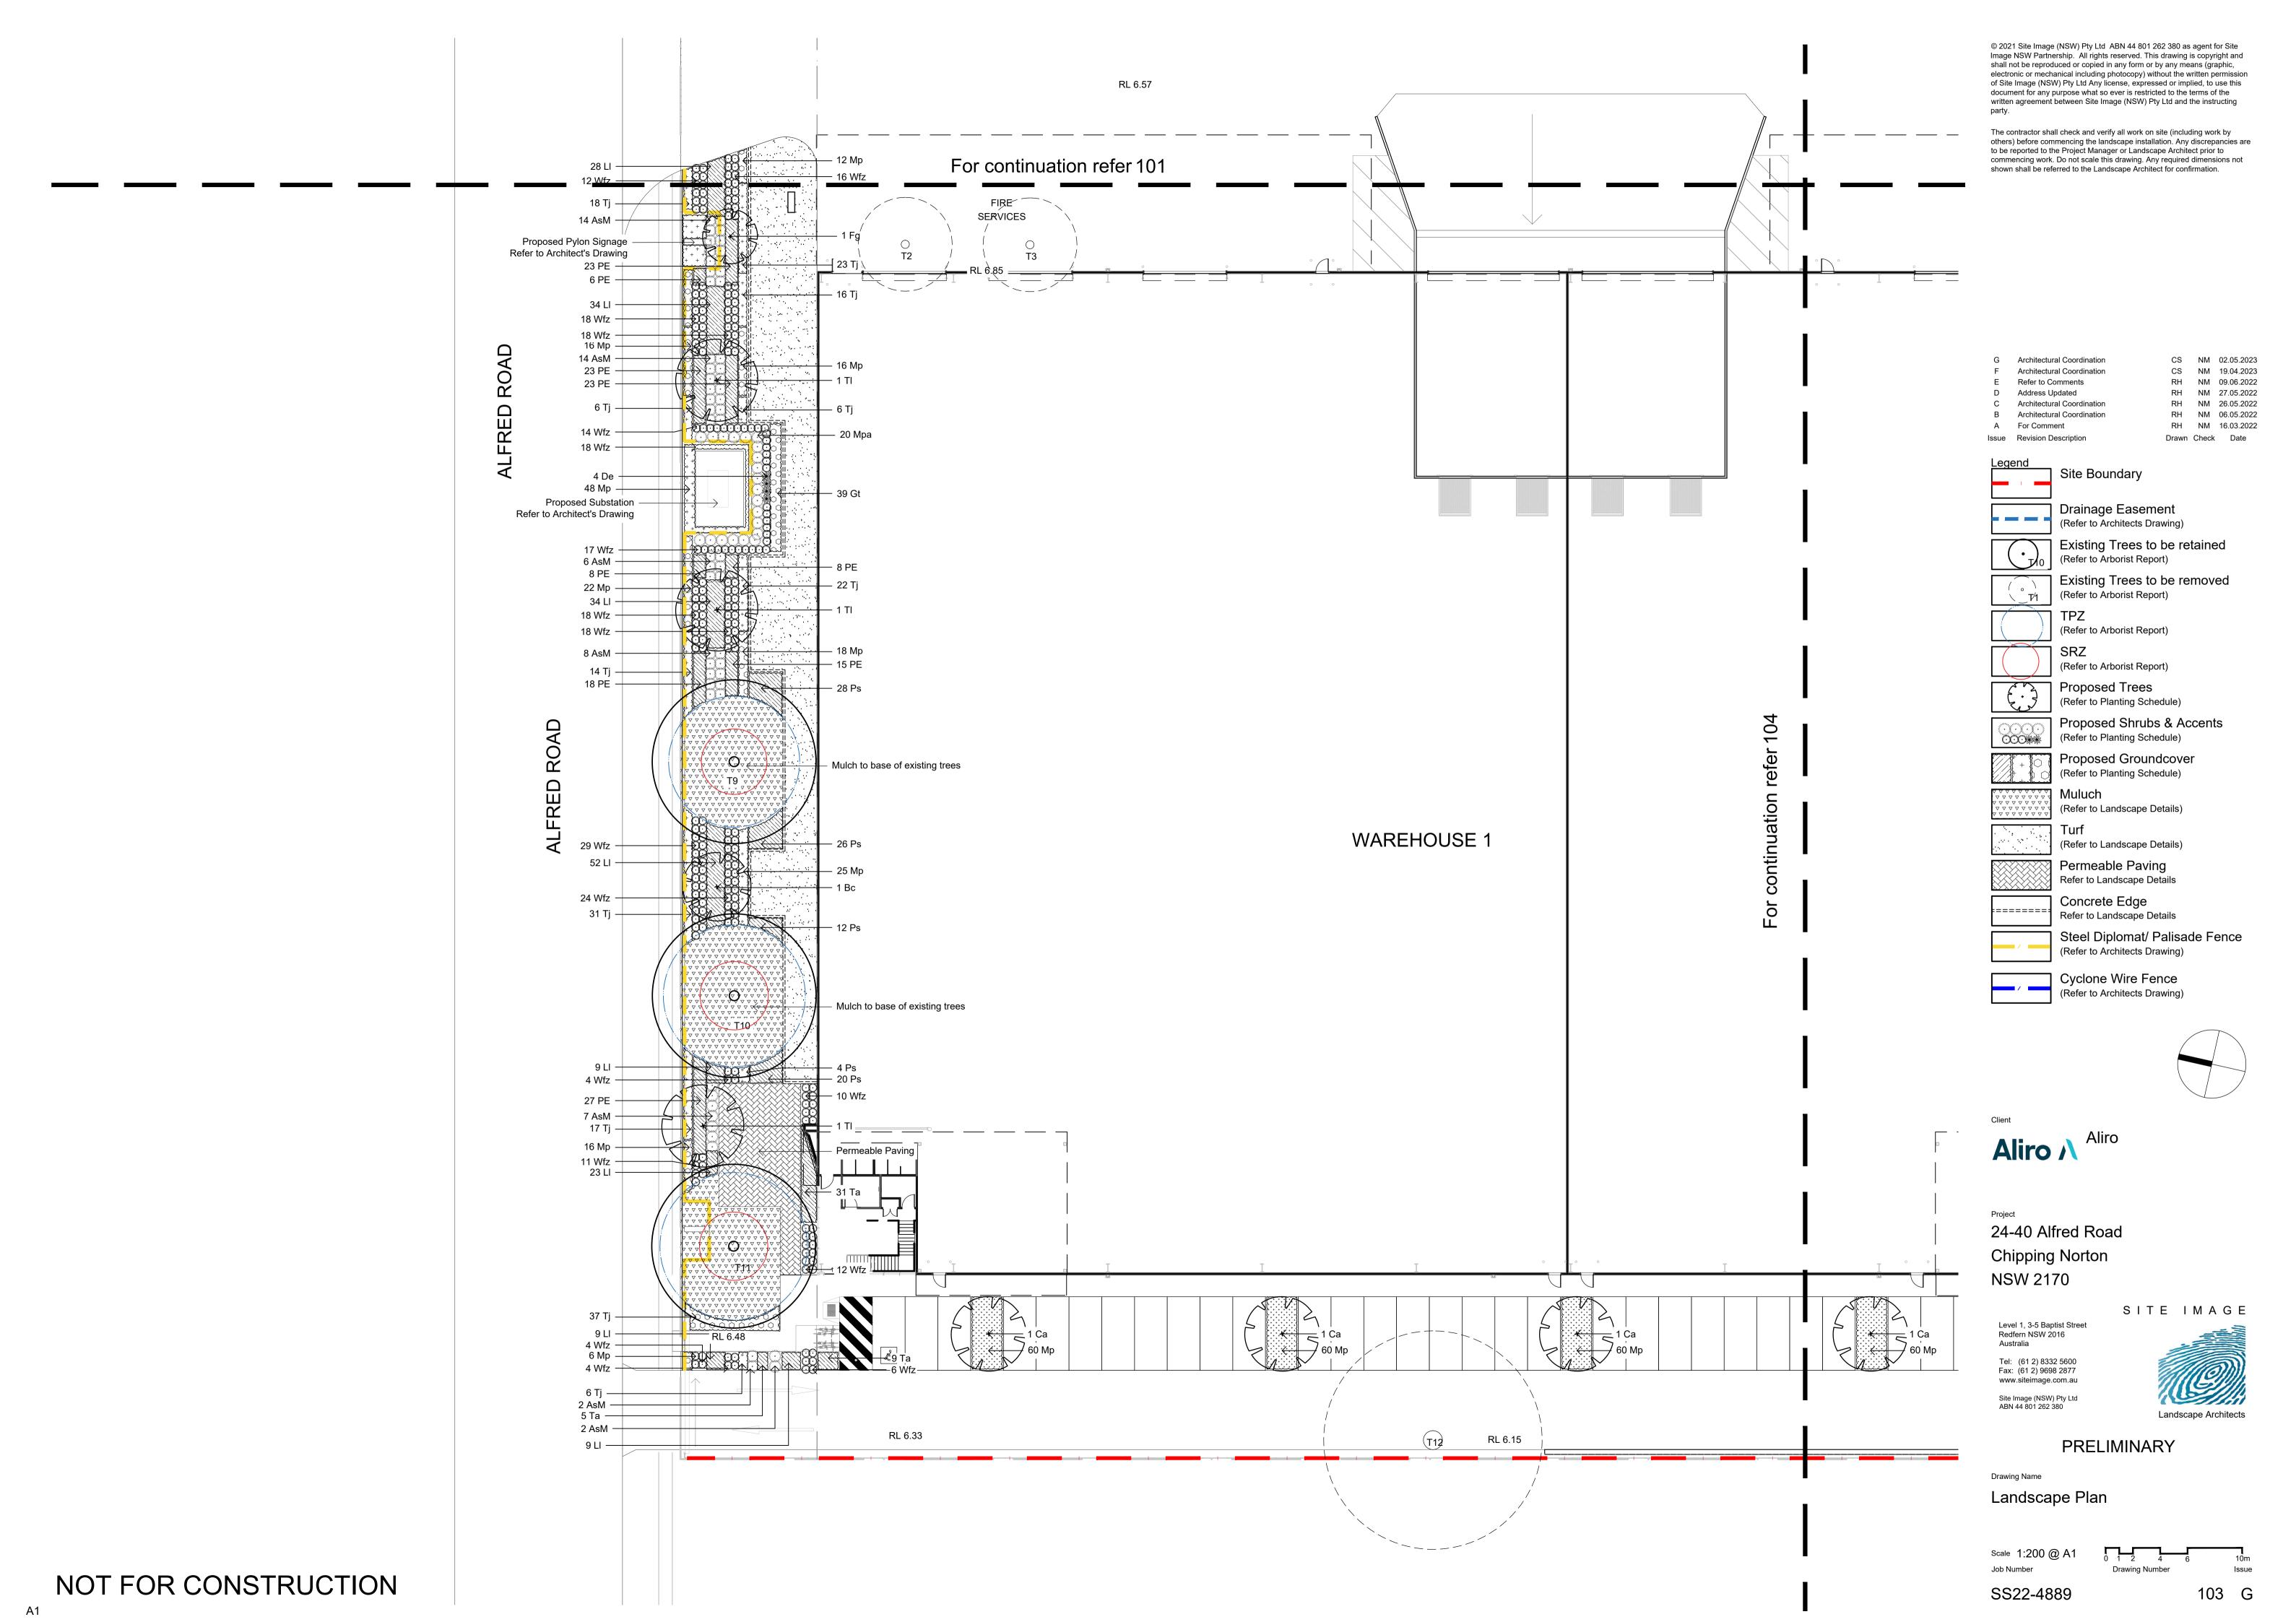


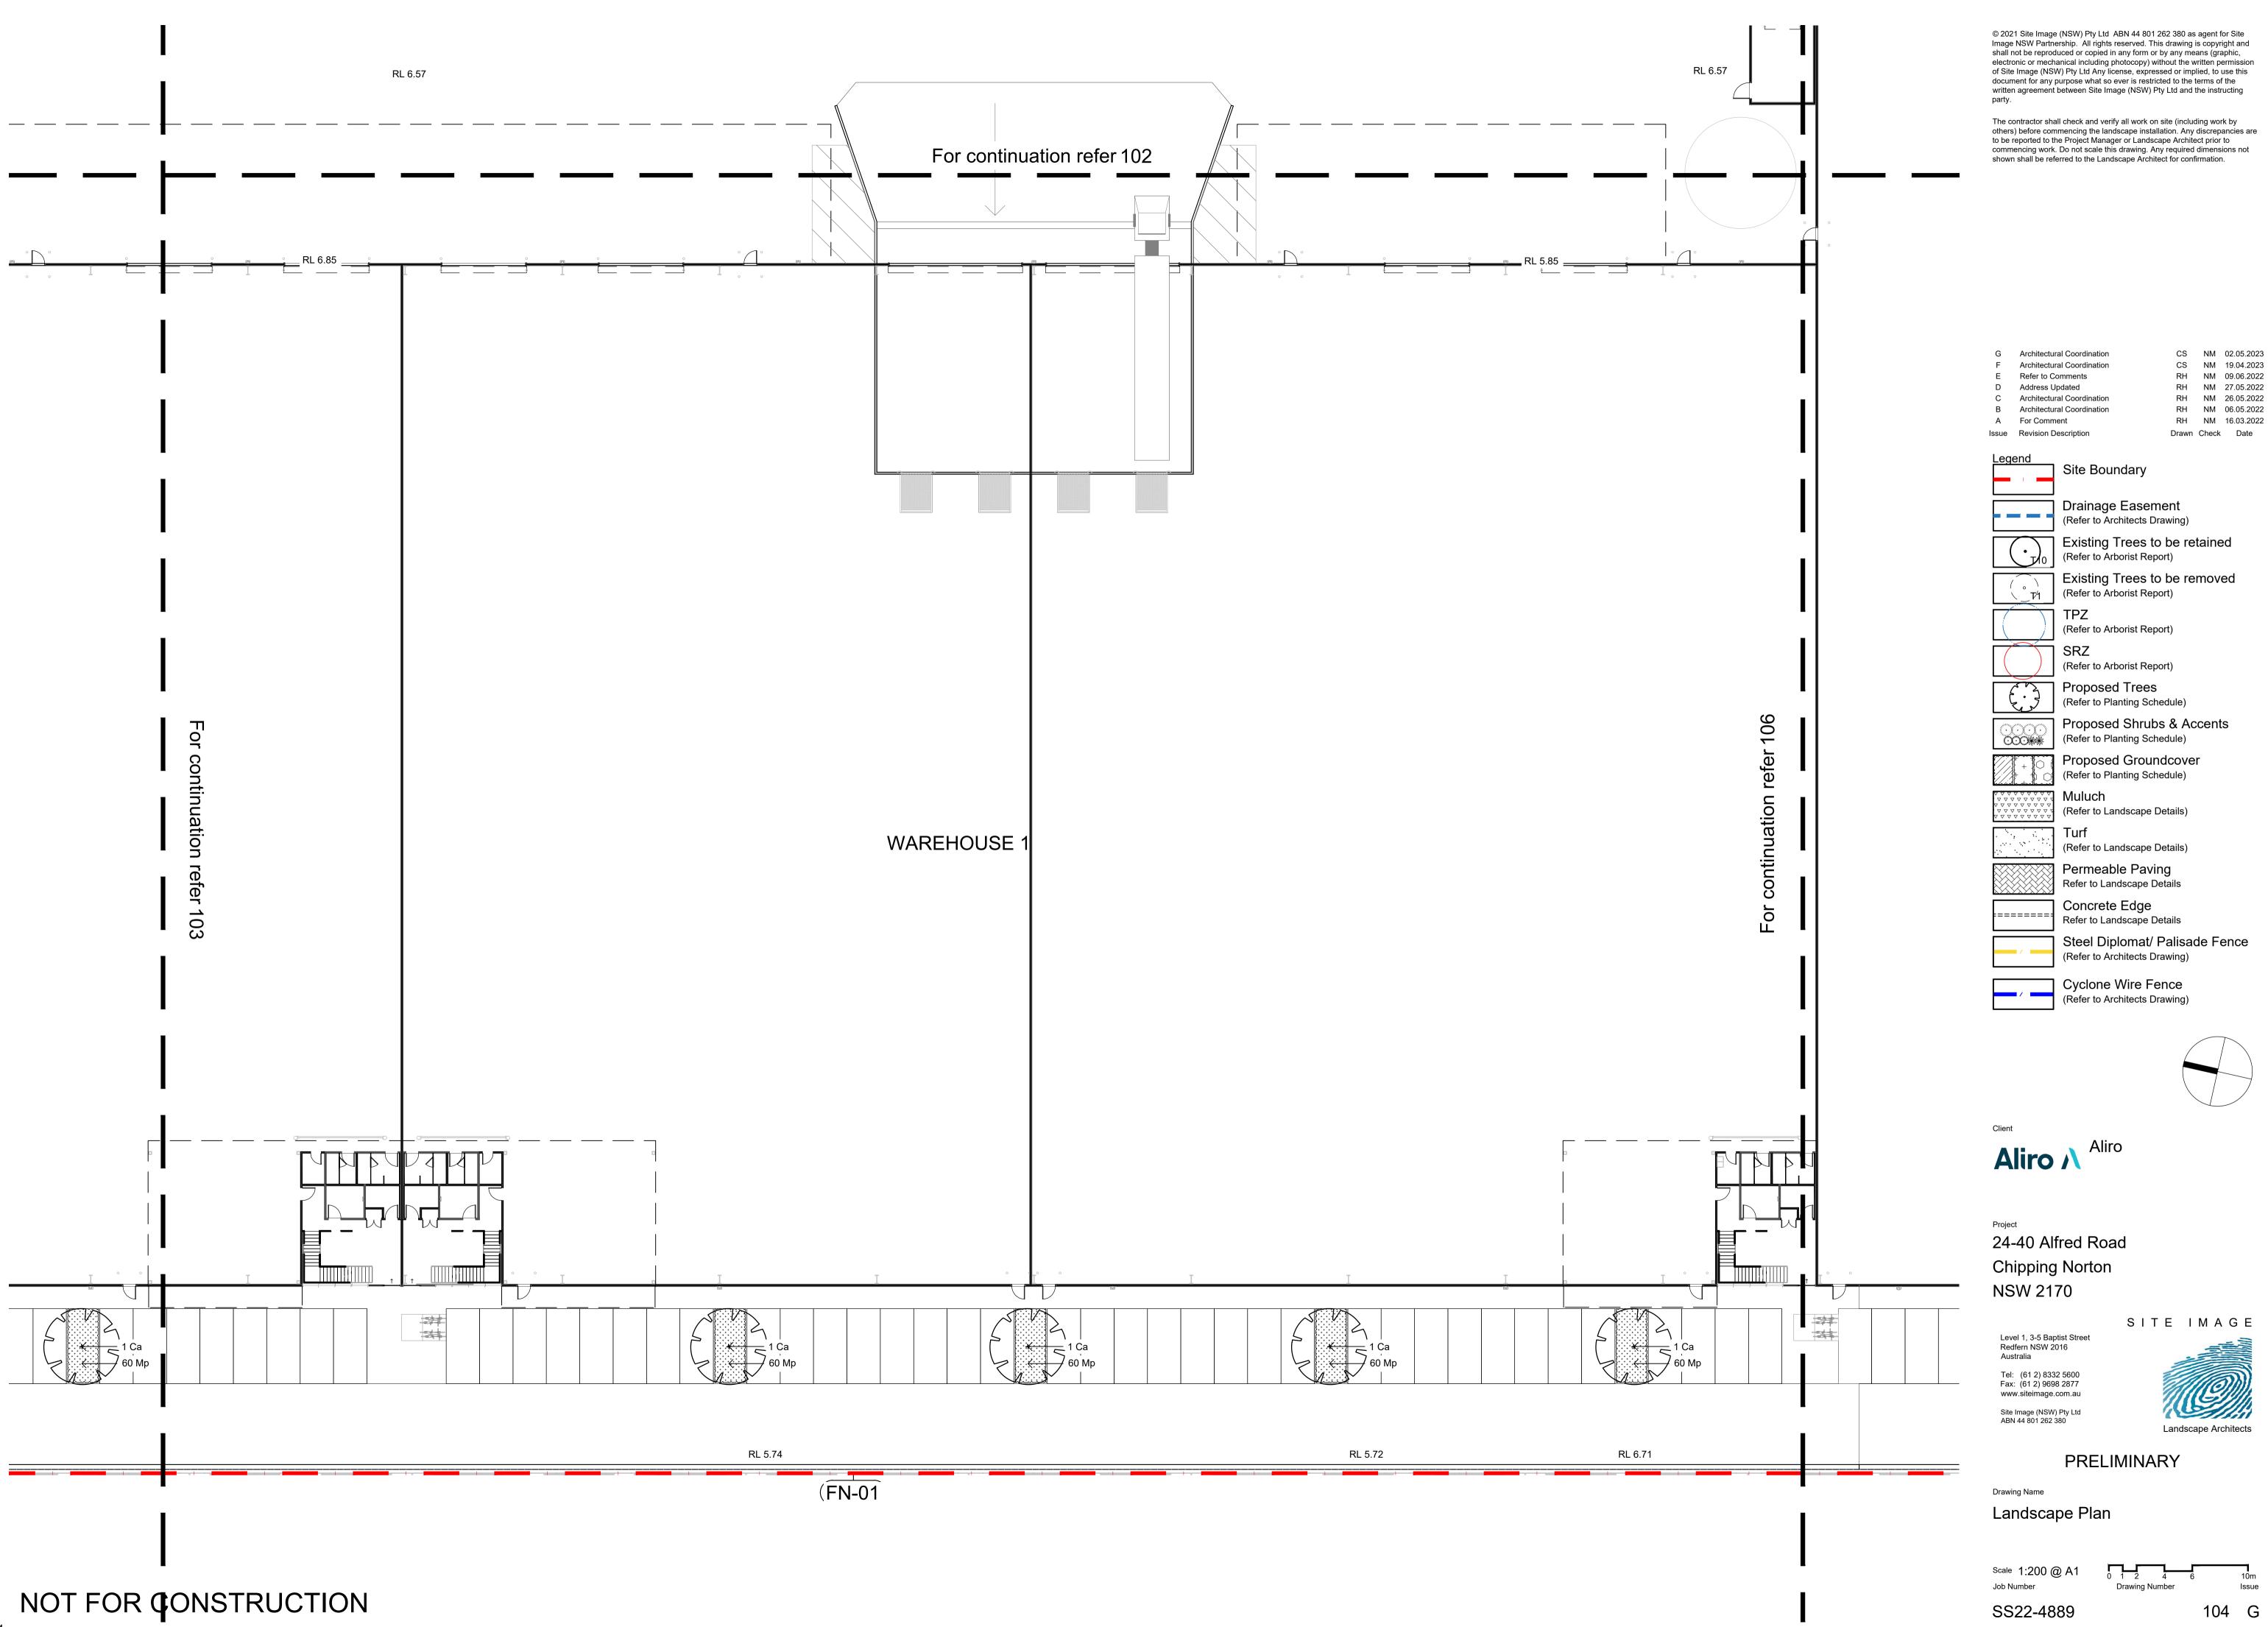


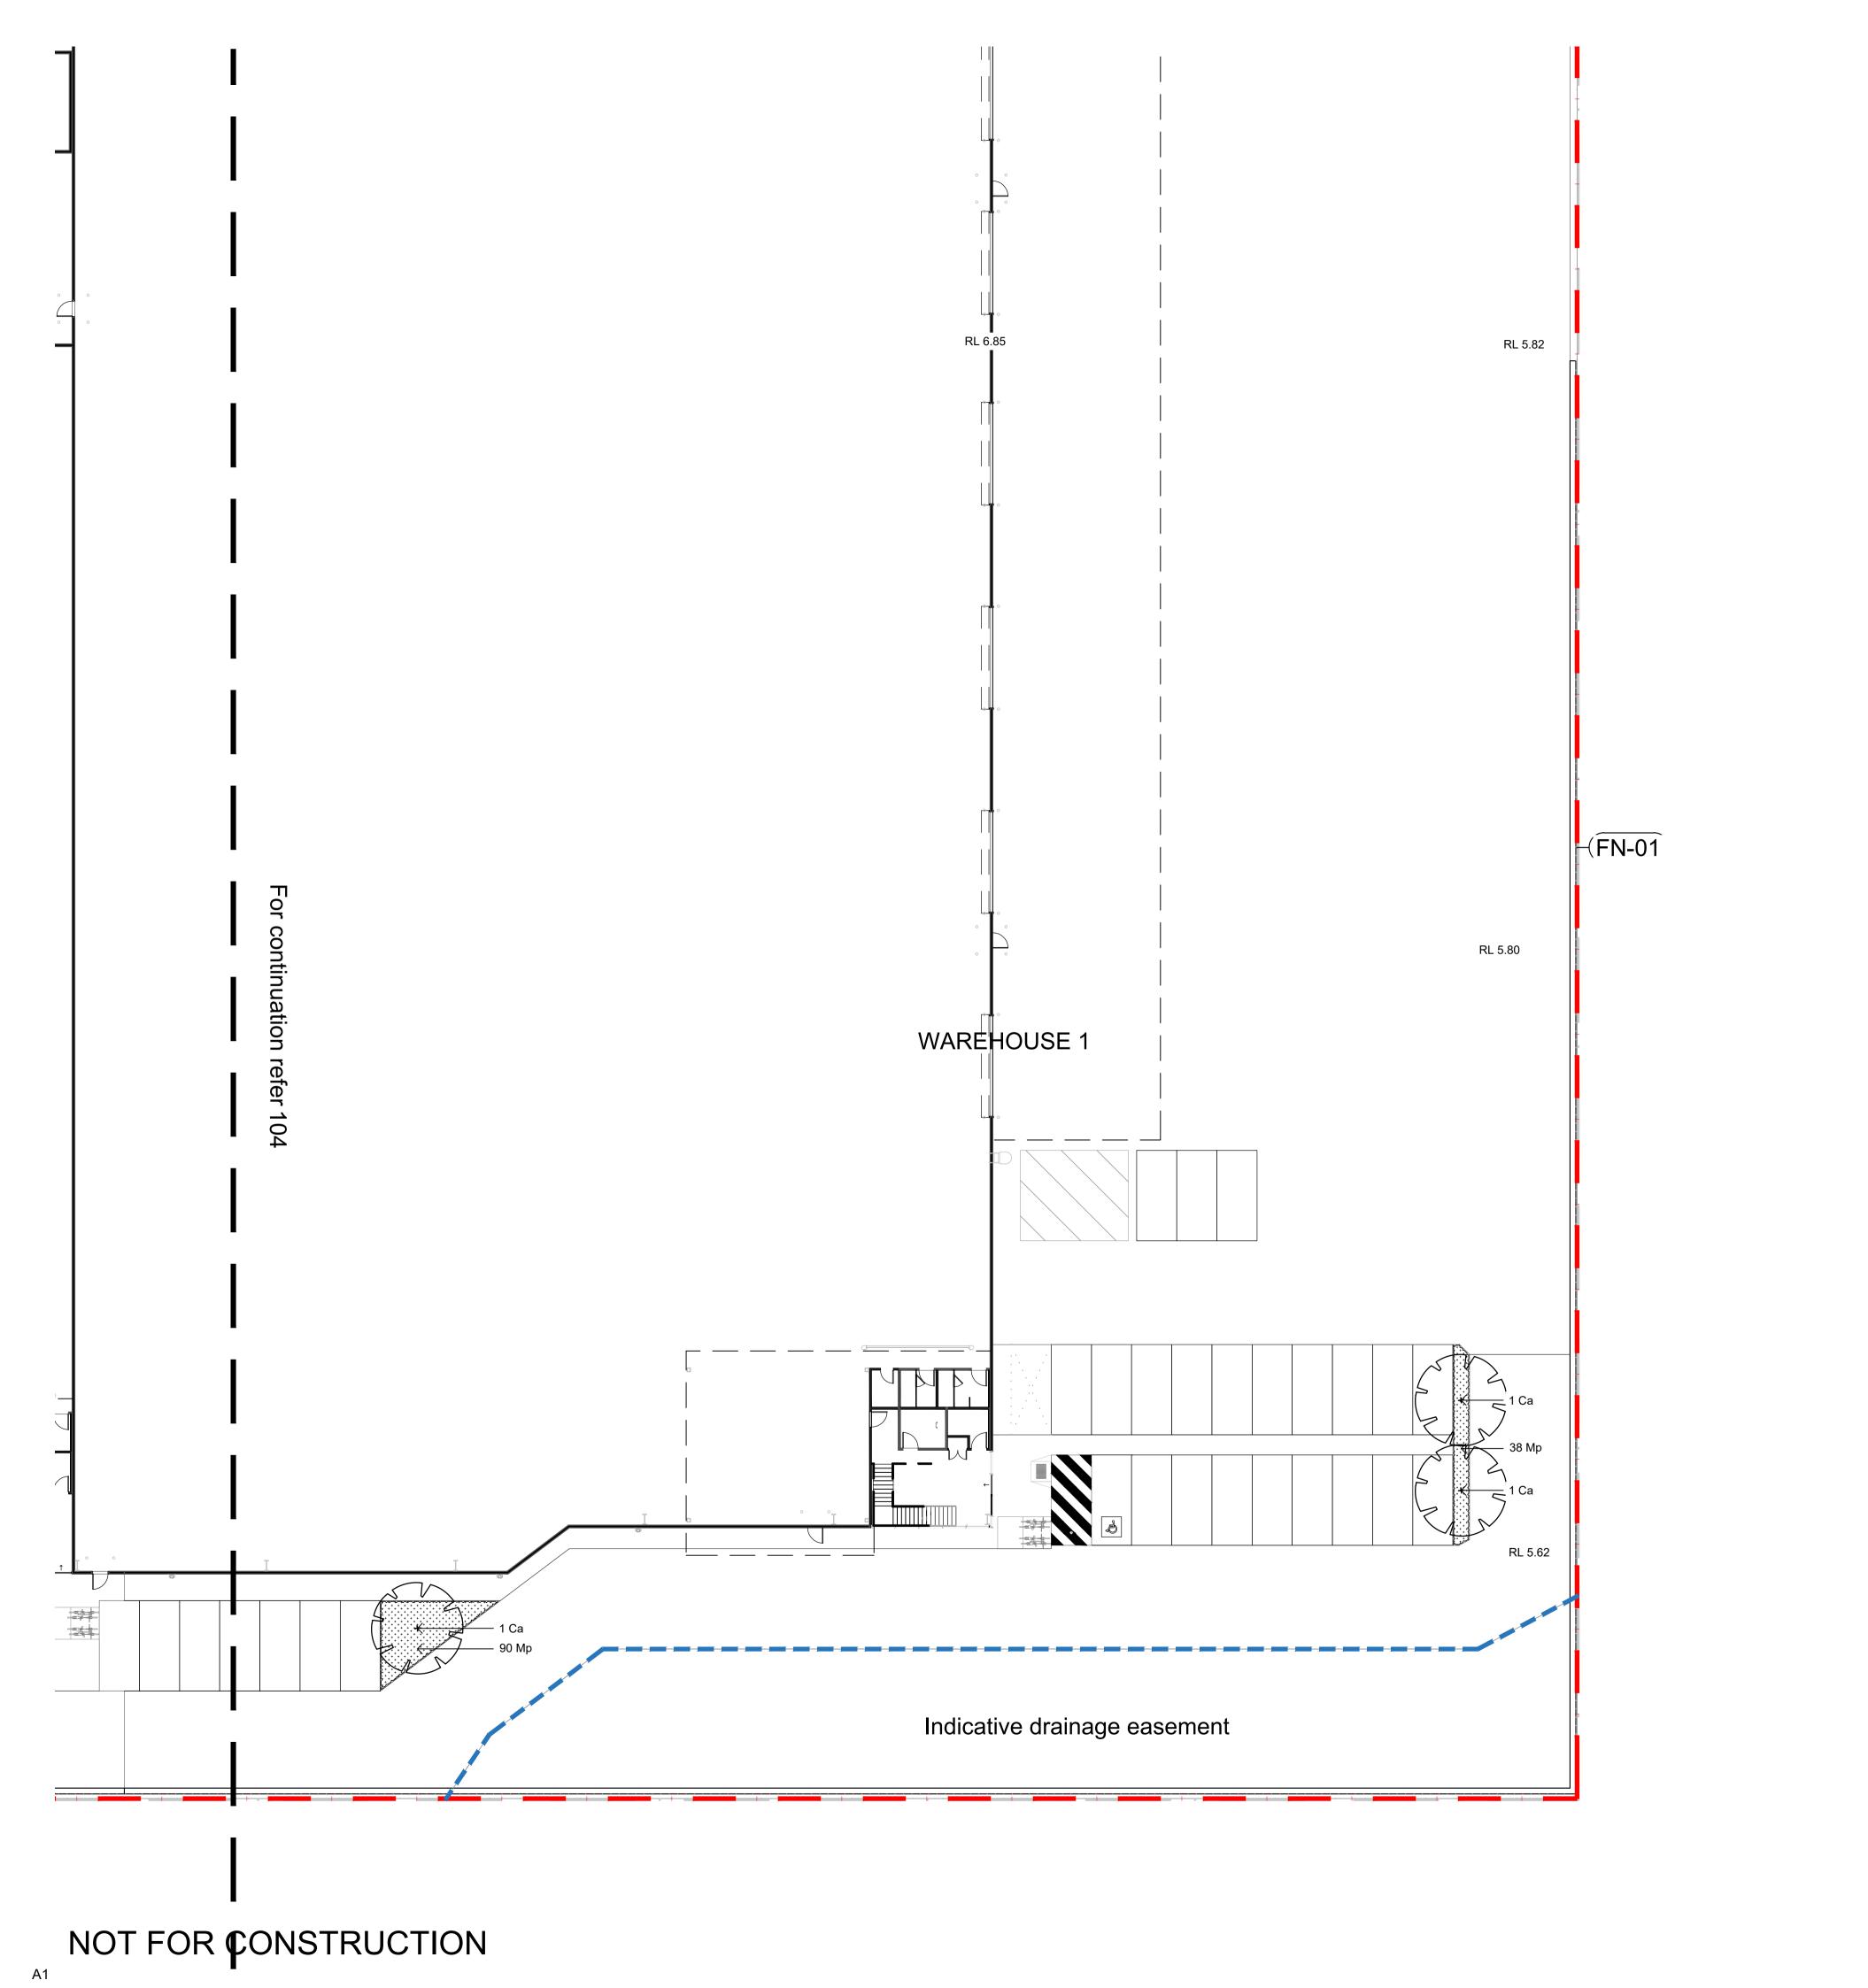

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(Refer to Architects Drawing) Existing Trees to be retained (Refer to Arborist Report)

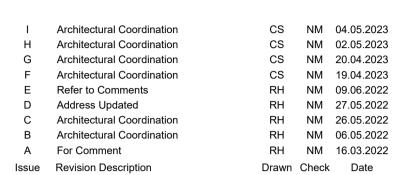



### (Refer to Arborist Report)

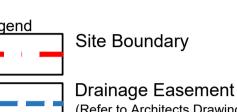(Refer to Arborist Report)


#### Proposed Trees (Refer to Planting Sche (Refer to Planting Schedule)

Proposed Shrubs & Accents (Refer to Planting Schedule) Proposed Groundcover

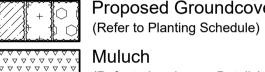


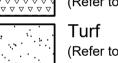


(Refer to Landscape Details)

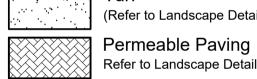


Refer to Landscape Details Concrete Edge

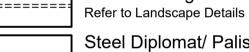

Steel Diplomat/ Palisade Fence (Refer to Architects Drawing)

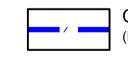

Cyclone Wire Fence (Refer to Architects Drawing)

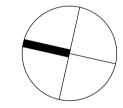

Aliro Aliro

24-40 Alfred Road

#### **Chipping Norton** NSW 2170

Level 1, 3-5 Baptist Street Redfern NSW 2016

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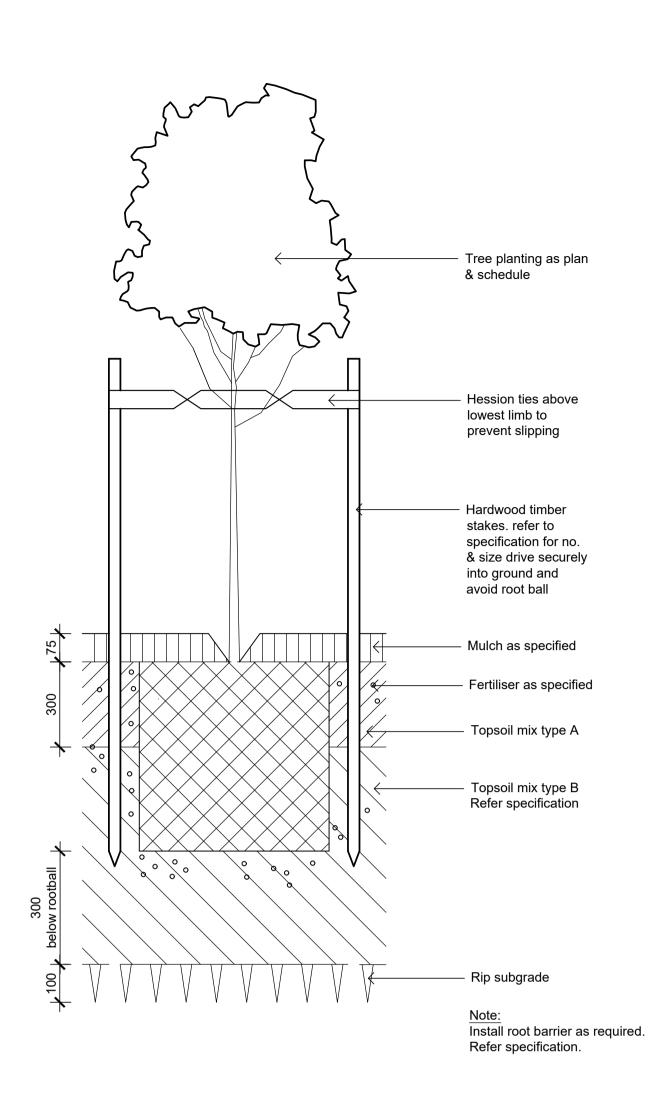
**Drawing Name** 

Landscape Plan

Scale 1:200 @ A1 105


SS22-4889

Job Number





Detail 75-200L Tree Planting on Grade

1:10

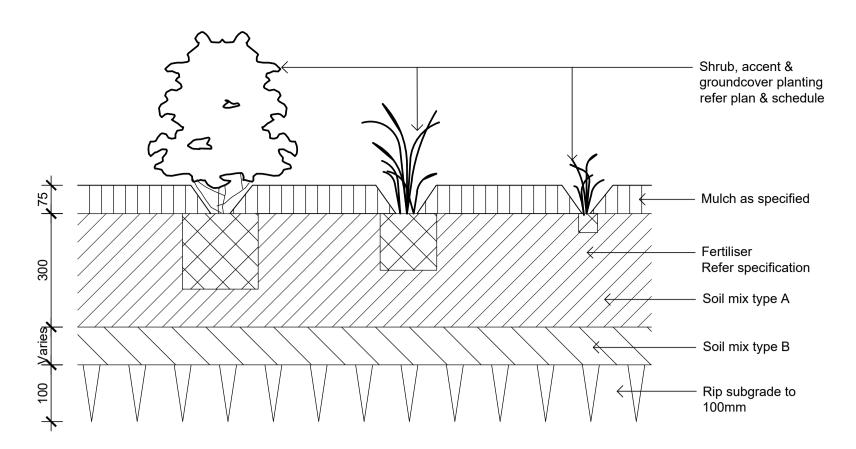


Detail Shrub Accent & Groundcover Planting on Grade

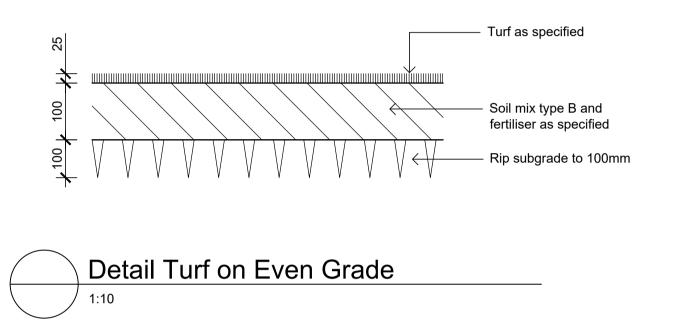

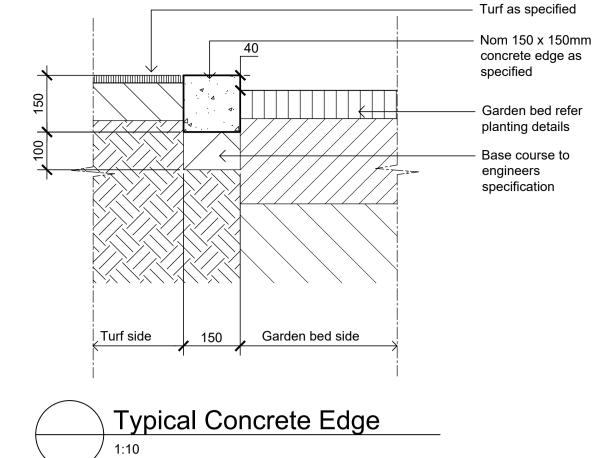



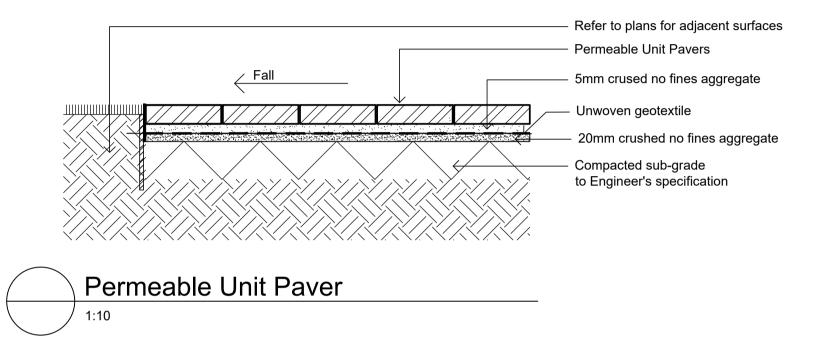

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The contractor shall check and verify all work on site (including work by others) before commencing the landscape installation. Any discrepancies are to be reported to the Project Manager or Landscape Architect prior to commencing work. Do not scale this drawing. Any required dimensions not shown shall be referred to the Landscape Architect for confirmation.

RH NM 27.05.2022 Address Updated B Architectural Coordination A For Comment

RH NM 06.05.2022 RH NM 16.03.2022 Issue Revision Description Drawn Check Date

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**PRELIMINARY** 

Landscape Details

Scale As Shown

501 C

Drawing Number

SS22-4889

Job Number

NOT FOR CONSTRUCTION

# 24-40 ALFRED STREET CHIPPING NORTON CIVIL WORKS PACKAGE



<u>DRAWING LIST</u>				
DRAWING No.	DRAWING TITLE			
21-957-C000	COVER SHEET, LOCALITY PLAN AND DRAWING LIST			
21-957-C001	LEGEND AND GENERAL NOTES			
21-957-C002	GENERAL ARRANGEMENT PLAN			
21-957-C003	TYPICAL SECTIONS			
BULK EARTHWORKS				
21-957-C010	BULK EARTHWORKS PLAN			
ROADWORKS AND DRAINAGE				
21-957-C021	ROADWORKS AND DRAINAGE PLAN SHEET 1			
21-957-C022	ROADWORKS AND DRAINAGE PLAN SHEET 2			
21-957-C023	ROADWORKS AND DRAINAGE PLAN SHEET 3			
21-957-C024	ROADWORKS AND DRAINAGE PLAN SHEET 4			
PAVEMENT				
21-957-C030	PAVEMENT PLAN			
EROSION AND SEDIMENT CONTROL				
21-957-C040	SEDIMENT AND EROSION CONTROL PLAN			
21-957-C041	SEDIMENT AND EROSION CONTROL DETAILS			
21-957-C050	PERVIOUS CATCHMENT PLAN			

LOCALITY PLAN

<u> </u>			
			Bar Sca
P3	ISSUED FOR COUNCIL APPROVAL	09-06-23	
P2	ISSUED FOR CLIENT REVIEW	26-05-23	
P1	ISSUED FOR CLIENT REVIEW	16-06-22	
Issue	Description	Date	

Aliro /

Scales	N.T.S	Drawn	QD	Pro
	N.1.3	Designed	QD	
Grid	GDA2020	Checked	LB	
Height Datum	AHD	Approved	AT	

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24-40 ALFRED STREET DEVELOPMENT

COVER SHEET, LOCALITY PLAN AND DRAWING LIST Civil Engineers and Project Managers

Level 7, 153
North Sydne

at&l

North Sydney NSW 2060 ABN 96 130 882 405 Tel: 02 9439 1777 Fax: 02 9923 1055 www.atl.net.au info@atl.net.au

FOR INFORMATION
NOT FOR CONSTRUCTION

Project - Drawing No.

21-957-C000

Project - Drawing No.

1ssue Project - Drawing No.

F:\21-957 Alfred St, Chipping Norton\6.0 Drgs\Civil\Final\000 SSD\21-957-C000.dwg

#### SITEWORKS NOTES

ORIGIN OF LEVELS:- REFER SURVEY NOTES.

CONCRETE OR UNIT PAVEMENTS.

- CONTRACTOR MUST VERIFY ALL DIMENSIONS AND EXISTING LEVELS ON SITE PRIOR TO COMMENCEMENT OF WORK, ANY DISCREPANCIES TO BE REPORTED TO AT & L.
- MAKE SMOOTH CONNECTION WITH EXISTING WORKS.
- ALL TRENCH BACKFILL MATERIAL SHALL BE COMPACTED TO THE SAME DENSITY AS THE ADJACENT MATERIAL.
- ALL SERVICE TRENCHES UNDER VEHICULAR PAVEMENTS SHALL BE BACKFILLED WITH SAND TO 300mm ABOVE PIPE. WHERE PIPE IS UNDER PAVEMENTS BACKFILL REMAINDER OF TRENCH TO UNDERSIDE OF PAVEMENT WITH SAND OR APPROVED GRANULAR MATERIAL COMPACTED IN 150mm LAYERS TO MINIMUM 98% MODIFIED MAXIMUM DRY DENSITY IN ACCORDANCE WITH AS 1289 5.2.1(2017). (OR A DENSITY INDEX OF NOT LESS THAN 75)
- PROVIDE 10mm WIDE EXPANSION JOINTS BETWEEN BUILDINGS AND ALL
- ASPHALTIC CONCRETE SHALL CONFORM TO RMS. SPECIFICATION R116.
- ALL BASECOURSE MATERIAL SHALL BE IGNEOUS ROCK QUARRIED MATERIAL TO COMPLY WITH RMS. FORM 3051 (UNBOUND), RMS. FORM ACCORDANCE WITH AS 1289 5.2.1(2017) FREQUENCY OF COMPACTION TESTING SHALL NOT BE LESS THAN 1 TEST PER 50m OF BASECOURSE MATERIAL PLACED.
- ALL SUB-BASE COURSE MATERIAL SHALL BE IGNEOUS ROCK QUARRIED MATERIAL TO COMPLY WITH RMS. FORM 3051, 3051.1 AND COMPACTED FREQUENCY OF COMPACTION TESTING SHALL NOT BE LESS THAN 1 TEST PER 50m OF SUB3BASE COURSE MATERIAL PLACED.
- 10. AS AN ALTERNATIVE TO THE USE OF IGNEOUS ROCK AS A SUB-BASE MATERIAL IN (9) A CERTIFIED RECYCLED CONCRETE MATERIAL COMPLYING WITH RMS. FORM 3051 AND 3051.1 WILL BE CONSIDERED. SUBJECT TO MATERIAL SAMPLES AND APPROPRIATE CERTIFICATIONS BEING PROVIDED TO THE SATISFACTION OF AT & L.
- 1. SHOULD THE CONTRACTOR WISH TO USE A RECYCLED PRODUCT THIS SHALL BE CLEARLY INDICATED IN THEIR TENDER AND THE PRICE DIFFERENCE BETWEEN AN IGNEOUS PRODUCT AND A RECYCLED PRODUCT SHALL BE CLEARLY INDICATED.
- 12. WHERE NOTED ON THE DRAWINGS THAT WORKS ARE TO BE CARRIED BY OTHERS, (eg. ADJUSTMENT OF SERVICES), THE CONTRACTOR SHALL BE RESPONSIBLE FOR THE CO-ORDINATION OF THESE WORKS. 3052 (BOUND) COMPACTED TO MINIMUM 98% MODIFIED DENSITY IN TO MINIMUM 95% MODIFIED DENSITY IN ACCORDANCE WITH A.S 1289 5.2.1(2017)
- ALL CIVIL WORKS TO BE CONDUCTED IN LINE WITH LIVERPOOL CITY COUNCIL GUIDELINES.

#### **SURVEY NOTES**

P3 | ISSUED FOR COUNCIL APPROVAL

ISSUED FOR CLIENT REVIEW

ISSUED FOR CLIENT REVIEW

Description

THE EXISTING SITE CONDITIONS SHOWN ON THE FOLLOWING DRAWINGS HAVE BEEN INVESTIGATED BY LAND PARTNERS SURVEYORS AND PLANNERS (SURVEY PLAN "SY075384.000.1.3" DATED 27-04-27), BEING REGISTERED SURVEYORS. THE INFORMATION IS SHOWN TO PROVIDE A BASIS FOR DESIGN. AT & L DOES NOT GUARANTEE THE ACCURACY OR COMPLETENESS OF THE SURVEY BASE OR ITS SUITABILITY AS A BASIS FOR CONSTRUCTION DRAWINGS.

SHOULD DISCREPANCIES BE ENCOUNTERED DURING CONSTRUCTION BETWEEN THE SURVEY DATA AND ACTUAL FIELD DATA, CONTACT AT&L.

THE FOLLOWING NOTES HAVE BEEN TAKEN DIRECTLY FROM THE ORIGINAL SURVEY DOCUMENTS.

#### **CONCRETE NOTES**

- 1. ALL WORKMANSHIP AND MATERIALS SHALL BE IN ACCORDANCE WITH AS 3600(2018) CURRENT EDITION WITH AMENDMENTS, EXCEPT WHERE VARIED BY THE CONTRACT DOCUMENTS.
- 2. CONCRETE QUALITY ALL REQUIREMENTS OF THE CURRENT ACSE CONCRETE SPECIFICATION DOCUMENT 1 SHALL APPLY TO THE FORMWORK, REINFORCEMENT AND CONCRETE UNLESS NOTED OTHERWISE.

ELEMENT	AS 3600 F'c MPa	SPECIFIED	NOMINAL
	AT 28 DAYS	SLUMP	AGG. SIZE
VEHICULAR BASE KERBS, PATHS, AND PITS	32 25	60 80	20 20

- CEMENT TYPE SHALL BE (ACSE SPECIFICATION) TYPE SL - PROJECT CONTROL TESTING SHALL BE CARRIED OUT IN ACCORDANCE WITH AS 1379.

- 3. NO ADMIXTURES SHALL BE USED IN CONCRETE UNLESS APPROVED IN WRITING BY AT & L.
- 4. CLEAR CONCRETE COVER TO ALL REINFORCEMENT FOR DURABILITY SHALL BE 40mm TOP AND 70mm FOR EXTERNAL EDGES UNLESS NOTED **OTHERWISE**
- 5. ALL REINFORCEMENT SHALL BE FIRMLY SUPPORTED ON MILD STEEL PLASTIC TIPPED CHAIRS, PLASTIC CHAIRS OR CONCRETE CHAIRS AT NOT GREATER THAN 1m CENTRES BOTH WAYS. BARS SHALL BE TIED AT ALTERNATE INTERSECTIONS.
- 6. THE FINISHED CONCRETE SHALL BE A DENSE HOMOGENEOUS MASS, COMPLETELY FILLING THE FORMWORK, THOROUGHLY EMBEDDING THE REINFORCEMENT AND FREE OF STONE POCKETS. ALL CONCRETE INCLUDING SLABS ON GROUND AND FOOTINGS SHALL BE COMPACTED AND CURED IN ACCORDANCE WITH R.M.S. SPECIFICATION R83. REINFORCEMENT SYMBOLS:
- N DENOTES GRADE 450 N BARS TO AS/NZS 4671 GRADE N
- R DENOTES 230 R HOT ROLLED PLAIN BARS TO AS/NZS 4671 SL DENOTES HARD-DRAWN WIRE REINFORCING FABRIC TO AS/NZS 4671

NUMBER OF BARS IN GROUP, BAR GRADE AND TYPE

17 N 20 250 NOMINAL BAR SIZE IN mm SPACING IN mm

THE FIGURE FOLLOWING THE FABRIC SYMBOL SL IS THE REFERENCE NUMBER FOR FABRIC TO AS/NZS 4671.

8. FABRIC SHALL BE LAPPED IN ACCORDANCE WITH THE FOLLOWING DETAIL:

**LAP TWO WIRES** 

#### KERBING NOTES

- ALL CONCRETE TO HAVE A MINIMUM COMPRESSIVE STRENGTH OF MPa 25 U.N.O IN REINFORCED CONCRETE NOTES.
- 2. ALL KERBS, GUTTERS, DISH DRAINS AND CROSSINGS TO BE CONSTRUCTED ON 100mm GRANULAR BASECOURSE COMPACTED TO MINIMUM 95% MODIFIED DRY DENSITY (AS 1289 5.2.1).
- 3. EXPANSION JOINTS (E.J) TO BE FORMED FROM 10mm COMPRESSIBLE CORK FILLER BOARD FOR THE FULL DEPTH OF THE SECTION AND CUT TO PROFILE. EXPANSION JOINTS TO BE LOCATED AT DRAINAGE PITS, ON TANGENT POINTS OF CURVES AND ELSEWHERE AT MAX 12m CENTRES EXCEPT FOR INTEGRAL KERBS WHERE THE EXPANSION JOINTS ARE TO MATCH THE JOINT LOCATIONS IN THE SLABS.
- WEAKENED PLANE JOINTS TO BE MIN 3mm WIDE AND LOCATED AT 3m CENTRES EXCEPT FOR INTEGRAL KERBS WHERE THE WEAKENED PLANE JOINTS ARE TO MATCH THE JOINT LOCATIONS IN THE SLABS.
- BROOMED FINISH TO ALL RAMPED AND VEHICULAR CROSSINGS. ALL OTHER KERBING OR DISH DRAINS TO BE STEEL FLOAT FINISHED.
- 6. IN THE REPLACEMENT OF KERB AND GUTTER :- EXISTING ROAD PAVEMENT IS TO BE SAWCUT 900mm U.N.O FROM THE LIP OF GUTTER. UPON COMPLETION OF THE NEW KERB AND GUTTER NEW BASECOURSE AND SURFACE TO BE LAID 600mm WIDE U.N.O. EXISTING ALLOTMENT DRAINAGE PIPES ARE TO BE BUILT INTO THE NEW KERB AND GUTTER WITH 100mm DIA HOLE, EXISTING KERB AND GUTTER IS TO BE COMPLETELY REMOVED WHERE NEW KERB AND GUTTER IS SHOWN.



Bar Scales

09-06-23

26-05-23

16-06-22

Date

CONTRACTOR SHALL CALL; DIAL BEFORE YOU DIG 1100 PRIOR TO COMMENCEMENT OF WORK TO OBTAIN ALL CURRENT SERVICE AUTHORITY PLANS

#### **EROSION AND SEDIMENT CONTROL**

#### NOTES

#### **GENERAL INSTRUCTIONS**

- 1. THE SITE SUPERINTENDENT/ENGINEER WILL ENSURE THAT ALL SOIL AND WATER MANAGEMENT WORKS ARE LOCATED AS DOCUMENTED.
- 2. ALL WORK SHALL BE GENERALLY CARRIED OUT IN ACCORDANCE WITH a. LOCAL AUTHORITY REQUIREMENTS
- b. EPA REQUIREMENTS C. NSW DEPARTMENT OF HOUSING MANUAL "MANAGING URBAN STORMWATER, SOILS AND CONSTRUCTION", 4th EDITION, MARCH
- 3. MAINTAIN THE EROSION CONTROL DEVICES TO THE SATISFACTION OF THE SUPERINTENDENT AND THE LOCAL AUTHORITY.
- 4. WHEN STORMWATER PITS ARE CONSTRUCTED, PREVENT SITE RUNOFF ENTERING UNLESS SEDIMENT FENCES ARE ERECTED AROUND PITS.
- 5. CONTRACTOR IS TO ENSURE ALL EROSION & SEDIMENT CONTROL DEVICES ARE MAINTAINED IN GOOD WORKING ORDER AND OPERATE EFFECTIVELY. REPAIRS AND OR MAINTENANCE SHALL BE UNDERTAKEN AS REQUIRED. PARTICULARLY FOLLOWING STORM EVENTS.

#### LAND DISTURBANCE

- 6. WHERE PRACTICAL, THE SOIL EROSION HAZARD ON THE SITE WILL BE KEPT AS LOW AS POSSIBLE. TO THIS END, WORKS SHOULD BE UNDERTAKEN IN THE FOLLOWING SEQUENCE:
- (A) INSTALL A WIND FENCE ALONG THE BOUNDARIES AS SHOWN ON PLAN. REFER DETAIL.
- (B) INSTALL A SEDIMENT FENCE ALONG THE BOUNDARIES AS SHOWN ON PLAN. REFER DETAIL.
- (C) CONSTRUCT STABILISED CONSTRUCTION ENTRANCE TO LOCATION AS DETERMINED BY SUPERINTENDENT/ENGINEER. REFER DETAIL.
- (D) INSTALL SEDIMENT BASIN AS SHOWN ON PLAN
- (E) INSTALL SEDIMENT TRAPS AS SHOWN ON PLAN.
- (F) UNDERTAKE SITE DEVELOPMENT WORKS IN ACCORDANCE WITH THE ENGINEERING PLANS. WHERE POSSIBLE, PHASE DEVELOPMENT SO THAT LAND DISTURBANCE IS CONFINED TO AREAS OF WORKABLE SIZE.

#### **EROSION CONTROL**

- 7. DURING WINDY WEATHER, LARGE, UNPROTECTED AREAS WILL BE KEPT MOIST (NOT WET) BY SPRINKLING WITH WATER TO KEEP DUST UNDER CONTROL.
- 8. FINAL SITE LANDSCAPING WILL BE UNDERTAKEN AS SOON AS POSSIBLE AND WITHIN 20 WORKING DAYS FROM COMPLETION OF CONSTRUCTION ACTIVITIES.

#### SEDIMENT CONTROL

- 9. STOCKPILES WILL NOT BE LOCATED WITHIN 2 METRES OF HAZARD AREAS, INCLUDING LIKELY AREAS OF CONCENTRATED OR HIGH VELOCITY FLOWS SUCH AS WATERWAYS. WHERE THEY ARE BETWEEN 2 AND 5 METRES FROM SUCH AREAS, SPECIAL SEDIMENT CONTROL MEASURES SHOULD BE TAKEN TO MINIMISE POSSIBLE POLLUTION TO DOWNSLOPE WATERS, E.G. THROUGH INSTALLATION OF SEDIMENT
- 10. ANY SAND USED IN THE CONCRETE CURING PROCESS (SPREAD OVER THE SURFACE) WILL BE REMOVED AS SOON AS POSSIBLE AND WITHIN 10 WORKING DAYS FROM PLACEMENT.
- 11. WATER WILL BE PREVENTED FROM ENTERING THE PERMANENT DRAINAGE SYSTEM UNLESS IT IS RELATIVELY SEDIMENT FREE. I.E. THE CATCHMENT AREA HAS BEEN PERMANENTLY LANDSCAPED AND/OR ANY LIKELY SEDIMENT HAS BEEN FILTERED THROUGH AN APPROVED
- 12. TEMPORARY SOIL AND WATER MANAGEMENT STRUCTURES WILL BE REMOVED ONLY AFTER THE LANDS THEY ARE PROTECTING ARE REHABILITATED.

#### OTHER MATTERS

- 13. ACCEPTABLE RECEPTORS WILL BE PROVIDED FOR CONCRETE AND MORTAR SLURRIES, PAINTS, ACID WASHINGS, LIGHT-WEIGHT WASTE MATERIALS AND LITTER.
- 14. ANY EXISTING TREES WHICH FORM PART OF THE FINAL LANDSCAPING PLAN WILL BE PROTECTED FROM CONSTRUCTION ACTIVITIES BY:
- (A) PROTECTING THEM WITH BARRIER FENCING OR SIMILAR MATERIALS INSTALLED OUTSIDE THE DRIP LINE
- (B) ENSURING THAT NOTHING IS NAILED TO THEM
- (C) PROHIBITING PAVING, GRADING, SEDIMENT WASH OR PLACING OF STOCKPILES WITHIN THE DRIP LINE EXCEPT UNDER THE FOLLOWING CONDITIONS.
- (I) ENCROACHMENT ONLY OCCURS ON ONE SIDE AND NO CLOSER TO THE TRUNK THAN EITHER 1.5 METRES OR HALF THE DISTANCE BETWEEN THE OUTER EDGE OF THE DRIP LINE AND THE TRUNK, WHICH EVER IS THE GREATER
- (II) A DRAINAGE SYSTEM THAT ALLOWS AIR AND WATER TO CIRCULATE THROUGH THE ROOT ZONE (E.G. A GRAVEL BED) IS PLACED UNDER ALL FILL LAYERS OF MORE THAN 300 MILLIMETRES DEPTH
- (III) CARE IS TAKEN NOT TO CUT ROOTS UNNECESSARILY NOR TO COMPACT THE SOIL AROUND THEM.

#### **EROSION AND SEDIMENT CONTROL**

#### NOTES CONTINUED

#### **STAGING**

- SUITABLE EROSION AND SEDIMENT CONTROLS SHALL BE DESIGNED. PROVIDED AND MAINTAINED BY THE CONTRACTOR THROUGHOUT ALL STAGES OF WORKS, INCLUDING AT COMPLETION OF THE BULK EARTHWORKS WHERE SHOWN ON AT&L DRAWINGS OR WHERE DIRECTED BY THE SUPERINTENDENT OR PENRITH CITY COUNCIL'S
- ENGINEERS. SEDIMENT AND EROSION CONTROLS ARE TO BE DESIGNED AND DOCUMENTED BY A SUITABLY QUALIFIED EXPERT ENGAGED BY THE CONTRACTOR AND APPROVED AS PART OF THE CONSTRUCTION ENVIRONMENTAL MANAGEMENT PLAN PRIOR TO THE COMMENCEMENT OF CONSTRUCTION. SUCH CONTROLS SHALL BE IN ACCORDANCE WITH THE RELEVANT REQUIREMENTS IN THE LATEST VERSION OF THE MANAGING URBAN STORMWATER: SOILS AND CONSTRUCTION GUIDELINE (LANDCOM).

#### **DEWATERING**

ANY DEWATERING WORKS TO BE AS PER THE DEWATERING PROCEDURE AS CONTAINED WITHIN THE CONSTRUCTION ENVIRONMENTAL MANAGEMENT PLAN (CEMP).

#### **DECOMMISSIONING / DEMOLITION**

DEMOLITION TO BE ACCORDANCE WITH "DEMO PLAN" DA04 BY WATSON YOUNG.


DEMOLITION OF EXISTING DWELLING TO BE CONDUCTED IN ACCORDANCE WITH THE PROVISIONS OF AS2601-2001 - DEMOLITION OF STRUCTURES BY CONTRACTORS EXPERIENCED IN THIS CLASS OF WORK AND HOLDING REQUIRED CURRENT PERMITS AND LICENSES AS REQUIRED.

EXISTING INTERNALS FENCING, CATTLE YARDS, UTILITIES AND OTHER REDUNDANT STRUCTURES TO BE DEMOLISHED AND REMOVED TO AN APPROVED WASTE MANAGEMENT FACILITY.

#### **EXISTING UNDERGROUND SERVICES NOTES**

- THE LOCATIONS OF UNDERGROUND SERVICES SHOWN IN THIS SET OF DRAWINGS HAVE BEEN PLOTTED FROM SURVEY INFORMATION AND SERVICE AUTHORITY INFORMATION. THE SERVICE INFORMATION HAS BEEN PREPARED ONLY TO SHOW THE APPROXIMATE POSITIONS OF ANY KNOWN SERVICES AND MAY NOT BE AS CONSTRUCTED OR ACCURATE.
- AT & L CAN NOT GUARANTEE THAT THE SERVICES INFORMATION SHOWN ON THESE DRAWINGS ACCURATELY INDICATES THE PRESENCE OR ABSENCE OF SERVICES OR THEIR LOCATION AND WILL ACCEPT NO LIABILITY FOR INACCURACIES IN THE SERVICES INFORMATION SHOWN FROM ANY CAUSE WHATSOEVER.
- CONTRACTORS SHALL TAKE DUE CARE WHEN EXCAVATING ONSITE INCLUDING HAND EXCAVATION WHERE NECESSARY.
- CONTRACTORS ARE TO CONTACT THE RELEVANT SERVICE AUTHORITY PRIOR TO COMMENCEMENT OF EXCAVATION WORKS.
- CONTRACTORS ARE TO UNDERTAKE A SERVICES SEARCH, PRIOR TO COMMENCEMENT OF WORKS ON SITE. SEARCH RESULTS ARE TO BE KEPT ON SITE AT ALL TIMES.

#### SITEWORKS LEGEND: **————** EXISTING BOUNDARY PROPOSED BOUNDARY — e — e — EXISTING ELECTRICAL — — t — — t — EXISTING TELSTRA — — s — — s — EXISTING SEWER EXISTING SEWER MANHOLE EXISTING POWER POLE EXISTING TELSTRA PIT **EXISTING WATER STOP VALVE EXISTING WATER HYDRANT EXISTING SEWER PIT** ---- · · 48.00 · · --- PROPOSED MAJOR CONTOUR ---- PROPOSED MINOR CONTOUR ----- 48.20 · PROPOSED SURFACE LEVEL F48.00 FFL 48.00 PROPOSED FINISHED FLOOR LEVEL PROPOSED INTEGRAL KERB ONLY PROPOSED INTEGRAL KERB AND GUTTER PROPOSED KERB AND GUTTER KO PROPOSED KERB ONLY PROPOSED PRAM RAMP $(A \setminus 1)$ STORMWATER PIT LABEL PROPOSED GRATED SURFACE INLET PIT PROPOSED JUNCTION PIT WITH SOLID COVER

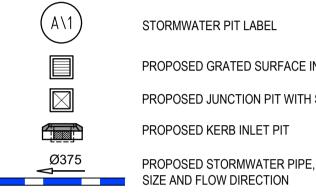

PROPOSED GRATED DRAIN

PROPOSED GUARD RAIL

PROPOSED RETAINING WALL

#### SEDIMENT AND EROSION LEGEND

— SEDIMENT FENCE ----> ----> CATCH DRAIN BARRIER FENCE MESH AND GRAVEL INLET FILTER (SD 6-11)

> GEOTEXTILE INLET (SD 6-12) STABILISED SITE ACCESS AND TRUCK WASH DOWN AREA

PROPOSED SITE ACCESS GATE

STRAW BALE FILTER (SD 6-7)



Client

Scales Project QD N.T.S Designed QD Checked GDA2020 LB Height Approved ΑT AHD Datum Title

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24-40 ALFRED STREET DEVELOPMENT

> LEGEND AND **GENERAL NOTES**

Civil Engineers and Project Managers Level 7, 153 Walker Street North Sydney NSW 2060 ABN 96 130 882 405 Tel: 02 9439 1777 Fax: 02 9923 1055 www.atl.net.au info@atl.net.au

FOR INFORMATION NOT FOR CONSTRUCTION Project - Drawing No. Issue 21-957-C001

